

CLAUSE 4.6 VARIATION REQUEST -HEIGHT OF BUILDING

Clause 4.3 Height of Buildings

212 Arden Street, 227-233 Coogee Bay Road, 5-7 Vicar Street and 15A Vicar Street, Coogee

Prepared for SIMMATOWN PTY LTD & CHEUNG PROPERTIES PTY March 2023

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1. INTRODUCTION

This Clause 4.6 Variation Request (**the Request**) has been prepared on behalf of Simmatown Pty Ltd & Cheung Properties Pty Ltd (**the applicant**) and accompanies an updated Development Application (**DA**) for the redevelopment of the Coogee Bay Hotel located at 212 Arden Street, 227-233 Coogee Bay Road and 5-7 and 15A Vicar Street, Coogee (**the site**).

The Request seeks an exception from strict application of the maximum building height prescribed for the site under clause 4.3 of Randwick Local Environmental Plan 2012 (**RLEP 2012**). The variation request is made pursuant to clause 4.6 of RLEP 2012.

This report should be read in conjunction with the documents submitted in support of the DA including the updated Statement of Environmental Effects prepared by Urbis (March 2023), architectural drawings prepared by Fender Katsalidis (March 2023), the Heritage Impact Statement prepared by Weir Phillips and Addendum View Analysis prepared by Urbis (enclosed in **Appendix A**). These documents form part of the Request.

The following sections of the report include:

- Section 2: description of the site and its local and regional context, including key features relevant to the proposed variation.
- Section 3: brief overview of the proposed development as outlined in further detail within the SEE and accompanying drawings.
- Section 4: identification of the development standard which is proposed to be varied, including the extent of the contravention.
- Section 5: outline of the relevant assessment framework for the variation in accordance with clause 4.6 of the LEP.
- Section 6: detailed assessment and justification of the proposed variation in accordance with the relevant guidelines and relevant planning principles and judgements issued by the Land and Environment Court.
- Section 7: summary and conclusion.

2. SITE CONTEXT

2.1. SITE DESCRIPTION

The site comprises four allotments, including 212 Arden Street, 227-233 Coogee Bay Road, 5-7 Vicar Street and 15A Vicar Street, Coogee. Key characteristics of the site include:

- The site is configured as a slightly irregular rectangular shape and has a total area of 8,501sqm.
- The site has a primary frontage to Arden Street of approximately 80m and a frontage to Coogee Bay Road of approximately 100m.
- The site falls approximately 7.79m from the south west corner on Vicar Street down to the north east intersection of Coogee Bay Road and Arden Street.
- The land is currently devoid of any significant vegetation. There is some planted vegetation within the frontage area to Arden Street in the beer garden and along the southern driveway.
- The eastern portion of the site, excluding the lots fronting Vicar Street, is a local heritage listed item (Item I48) under the RLEP 2012. The site is not with a heritage conservation area.

Existing development within the site is summarised in **Table 1** and detailed in the aerial photograph at **Figure 1**. Site photographs are provided at **Figure 2**.

Table 1 Site details

Address	Legal Description	Current Development
212 Arden Street	Lot 1 DP872553	 This lot comprises: The Coogee Bay Hotel including a three-storey hotel building (c.1920s) located on the corner of Arden and Coogee Bay Road. Within the hotel site, there are various structures including: A sandstone building with tiled hipped roof setback behind the courtyard/beer garden on Arden Street Selina's nightclub Drive through liquor store with associated car port and hotel loading area accessible via Arden Street Along the Coogee Bay Road frontage, there are 2 x two storey interwar buildings with ground floor retail including the entrance to the hotel's sports bar and gaming room Fronting Vicar Street is a five storey hotel accommodation building (also known as 9 Vicar Street).
227-233 Coogee Bay Road	Lot A DP437308	 Located on the north west corner of the site, the lot comprises: 2 x two storey Federation shopfront building with retail uses at ground floor level; and 1 three storey inter war building
5-7 Vicar Street	Lot B DP437308	Two storey inter war residential flat building, accessible via Vicar Street
15A Vicar Street	Lot A DP337724	Three storey inter war residential flat building, accessible via Vicar Street

Figure 1 Aerial photograph



Source: Urbis

Figure 2 Site photographs



Picture 1 Corner of Arden Street and Coogee Bay Road Source: Urbis



Picture 2 Existing boutique hotel within the site at 9 Vicar Street Source: Google Maps



Picture 3 Existing development at corner of Coogee Bay Road and Vicar Street Source: Google Maps

2.2. LOCALITY CONTEXT

The site when viewed in its broader context within Coogee is illustrated in **Figure 3**. This context is important when assessing the reasonableness of the variation to the height of building standard.

From an analysis of the site context undertaken by Urbis and ae design partnership, the following is noted:

- As shown in **Figure 3**, the site sits in a low central 'bowl' or valley surrounded by sloping topography which rises to the south, west and north. The overall topography generally falls in elevation from the south west to the north east, with an approximate 7.5 metre fall from Vicar Street to Arden Street.
- The site is in the middle of the Coogee local centre, which has a highly varied scale of development, creating a skyline characterised by a mix of traditional small scale buildings and larger residential and hotel developments.
- Coogee Bay Road is characterised by attached shop top buildings ranging from one to three storeys in height with a mix of shops, restaurants and cafes located on the ground floor. These buildings are interspersed with three to four storey residential developments.
- The site sits at a zone interface, as the properties to the west along Vicar Street are zoned R3 Medium Density Residential. Vicar Street is characterised by higher density residential uses with a mix of single detached dwellings and residential flat buildings ranging from two to four storeys.
- The site is within the Foreshore Scenic Protection Area and is proximate to coastal areas such as Coogee Beach and Thompsons Bay to the immediate east. The site is along the Bondi to Coogee coastal walking track, which provides access to numerous other beaches along the coastline to the north and south. Significant public open space and formal recreation areas are also located north of the site at Coogee Oval.
- Immediately to the south of the site is a range of medium density residential flat buildings ranging
 predominantly from three to five storeys. Further to the south at the corner of Arden and Carr Streets is
 the Crowne Plaza hotel, which comprises a nine storey building.
- Owing to the historical evolution of the development of Coogee, many existing buildings are greater in height than the current controls – in part resulting from changing planning controls over time. This includes the residential developments to the south of the site and the Crowne Plaza hotel.



Figure 3 Site context plan

Source: ae design partnership

2.3. PLANNING BACKGROUND

As outlined in the updated Statement of Environmental Effects (March 2023), development consent DA599/95 was approved by Randwick Council in April 1996 and it granted consent for:

- The Vicar Wing comprising a hotel building containing 4 floors of hotel rooms over three levels of car parking;
- Convention Wing comprising one part level and two levels containing a total of 52 hotel rooms over the existing Selina's Nightclub;
- An Entertainment/Convention Centre a change of use of the existing Selina's and refurbishment of upper ground level rooms for conference rooms and associated facilities; and
- Refurbishment and rationalisation of existing 40 hotel rooms and provision of an additional 33 hotel rooms.

Overall, DA599/95 resulted in the following:

- FSR: 1.84:1 (permissible 1.5:1 Randwick LEP 119; Eastern Beaches REP 3:1 for tourist related uses)
- Height: 19m (permissible 12m but 15m with concurrence)

Based on Urbis' review of Council files, it appears that the current boutique hotel on Vicar Street is the hotel component approved by DA599/95. It was originally approved as a three storey hotel which was amended to a four storey hotel. The existing boutique hotel and DA599/95 massing is indicated in **Figure 4**.

This existing development consent is a mandatory relevant consideration for the Land and Environment Court under section 39(4) of the Land and Environment Court 1979: Kamenev v Woollahra Municipal Council (No 2) [2018] NSWLEC 1228 at [39]-[41]; MLC Properties v Camden Council (1997) 96 LGERA 52, 58; Omaya Investments Pty Ltd v Dean Street Holdings Pty Limited (No 5) [2020] NSWLEC 9 at [106].

Figure 4 Height plane diagram - existing and previously approved development



Source: Fender Katsalidis

3. PROPOSED DEVELOPMENT

This Request has been prepared to accompany an updated DA for the redevelopment of the Coogee Bay Hotel site located at 212 Arden Street, 227-233 Coogee Bay Road and 15A Vicar Street, Coogee. The site also includes 5-7 Vicar Street, Coogee.

The proposal comprises a considered mixed-use development outcome, with an integrated design which revitalises the site, complements the character of the area and provides public benefits back to the community. Since the lodgement of the development application in July 2021, refinements have been proposed to the scheme.

Specifically, this refined DA scheme seeks approval for the following:

- Demolition of the following existing buildings and structures on site:
 - Six storey hotel accommodation building 'Coogee Bay Boutique Accommodation'
 - Residential flat buildings at 15 and 5-7 Vicar Street
 - Retail tenancies along Coogee Bay Road (north-west portion of site but excluding the upper level façade of buildings on 212 Arden Street)
 - Portion of the current hotel and pub known as Selina's nightclub, as well as some existing hotel facilities and back of house spaces.
- Retention of the existing local heritage listed Coogee Bay Hotel including the majority of the Coogee Bay Road façade and beer garden. The roofline of the heritage hotel is retained as are the above ground level façade elements along Coogee Bay Road to the west of the pub on the lot known as 212 Arden Street, Coogee.
- Internal refurbishment works are proposed to expand hotel accommodation, including 32 new or upgraded hotel rooms and reconfiguration of internal hotel areas to accommodate a refreshed food and beverage and function offer, gaming room, bottle shop and bar areas.
- Upgrade of the beer garden area and construction of dining pavilions in this space.
- Construction of new awning elements along Coogee Bay Road and returning south along the Vicar Street frontage.
- A new three storey southern hotel wing south of the beer garden and north of the driveway access will incorporate ground floor food and beverage and two levels of hotel accommodation (including 15 hotel rooms).
- Operation of the Pub Premises generally reflecting existing hours of operation.
- Provision of ground level commercial uses including 11 new retail food and beverage tenancies (cafes/restaurants) fronting a ground floor eat street precinct and Coogee Bay Road. Use and fitout consents for these tenancies will be subject to separate approvals.
- Provision of a new maximum five-storey shop top housing building above the ground floor retail tenancies incorporating 58 apartments including a mix of 7 x 1-bed, 25 x 2-bed, 24 x 3-bedand 2 x 4-bed apartments.
- Excavation for and construction of two levels of basement (one partial at ground level) accessed off Arden Street, including a total of 159 parking spaces comprising:
 - 91 residential spaces including 15 visitor spaces and 1 accessible space
 - 68 hotel / retail spaces including 2 accessible spaces
 - 11 motorcycle parking spaces, car wash bay, end of trip facilities, loading and servicing provisions, waste storage and collection areas, lift access and provisions for plant and services equipment.
- Site landscaping works including the creation of a new through-site link (public laneway) which runs from Coogee Bay Road to Arden Street, wrapping through the hotel area north of the basement driveway access. New landscape areas also include deep soil landscape planting to the south of the shop top housing adjacent 17 Vicar Street, a planted driveway awning adjacent 230 Arden Street, Level 1

communal gardens and pool for the site residents. Planting along the Arden Street frontage of the beer garden will also be upgraded. Eight trees are proposed for removal.

 Subdivision of the site into two lots – one for the hotel / pub and one for the retail and residential accommodation.

This proposal comprises a considered mixed-use development outcome, with an integrated design which revitalises the site, complements the character of the area and provides public benefits back to the community.

This proposal demonstrates how the site will be repositioned to complement the existing hotel operation with upgraded accommodation facilities complemented by residential accommodation, create a wider range of entertainment and dining options, public meeting spaces and a more family friendly environment. An activated retail laneway provides a new café and dining precinct and access through the site to create an integrated built form outcome which enhances the public perception of the Coogee Bay Hotel.

The proposal is illustrated in the Architectural Drawings (**Appendix D**) and Architectural Design Report (**Appendix E**) prepared by Fender Katsalidis, as well as other design and supporting technical documentation provided in **Appendices A** through to **Y**.

Key details of the refined proposal are summarised in **Table 2** and a photomontage of the proposed development is provided in **Figure 5**.

Component	Proposal	
Site Area	8,501 sqm	
Subdivided Site Areas	Residential and Retail lot: 4,885 sqm Pub and Hotel lot: 3,616 sqm	
Land Uses	Hotel, pub, retail, shop top housing	
Height	Coogee Bay Hotel: 15.52 metres (no change) Shop top housing: 21.35 metres	
Gross Floor Area (GFA)	13,488 sqm (1.59:1)	
Through Site Link	Through site connection from Coogee Bay Road to Arden Street, via publicly accessible laneway / eat street.	
Landscaping	1,669 sqm of landscape area including 158 sqm of deep soil areas	
Accommodation	58 apartments comprising:	
	7 x 1 bedroom apartments	25 x 2 bedroom apartments
	24 x 3 bedroom apartments	2 x 4 bedroom apartments
Car Parking Spaces	159 parking spaces comprising:	
	92 residential including 15 residential visitor and 1 accessible spaces	67 hotel and retail spaces including 2 accessible spaces
End of Trip Facilities	58 sqm	
Motorbike Parking	11 spaces	
Bicycle Parking	7 retail bike spaces in basement 31 residential and 9 visitor bikes adjacent to the residential entries at Vicar Street (20 spaces at each entry)	

Table 2 Numeric overview of proposal

Component	Proposal
Loading / Servicing	Basement loading and servicing for the residential, retail and hotel
	component via shared loading dock

Figure 5 Artists impression of Shop Top Housing from corner of Coogee Bay Road and Vicar Street



Source: Fender Katsalidis

4. VARIATION OF HEIGHT OF BUILDINGS STANDARD

This section of the report identifies the development standard which is proposed to be varied, including the extent of the contravention. A detailed justification for the proposed variation is provided in **Section 6** of the report.

4.1. DEVELOPMENT STANDARD

A 12 m height of building control applies to the entire site as prescribed within clause 4.3 of RLEP 2012 and the associated Height of Building Map (refer to map extract in **Figure 6**).

The RLEP Dictionary defines building height (or 'height of building') as follows:

building height (or height of building) means:

- (a) in relation to the height of a building in metres the vertical distance from ground level (existing) to the highest point of the building, or
- (b) in relation to the RL of a building the vertical distance from the Australian Height Datum to the highest point of the building.

including plant and lift overrun, but excluding communication devices, antennae, satellite dishes, masts, flagpoles, chimneys, flues and the like.

Figure 6 RLEP 2012 Height of buildings map



Source: Urbis

4.2. EXISTING CONTRAVENTION

Three of the existing buildings within the site exceed the 12 metre height control and have maximum heights as follows:

- Boutique hotel along Vicar Street 19 metres.
- Retail building at the corner of Vicar Street and Coogee Bay Road 14.5 metres.
- Heritage hotel and pub building at the corner of Arden Street and Coogee Bay Road 15 metres.

In addition, a development consent for the site was granted by Randwick Council in April 1996 (DA599/95). The approved ridge line of the development measured 19 metres to the boutique hotel and 17.5 metres to the building envelope towards the centre of the site.

Figure 7 illustrates the existing and approved breaches to the RLEP 2012 height of building standard.

Figure 7 Height plane diagram - existing and previously approved development



Source: Fender Katsalidis

4.3. PROPOSED VARIATION TO HEIGHT OF BUILDINGS STANDARD


The proposed development presents a varied maximum height from 15.52m (existing hotel / pub building) to 21.35 metres (top of south residential wing roof roof for the shop top housing) across the site. At its greatest point, the proposed development exceeds the height of buildings development standard under the RLEP 2012 by a maximum of 9.35 metres. The variations to the height controls are outlined in the **Table 3**.

Location	RLEP 2012 Control	Proposed	Variation to RLEP 2012
Coogee Bay Hotel heritage roof	12 metres	15.52 metres (no change)	3.52 metres (no additional contravention proposed)
New hotel wing (Arden Street frontage)	12 metres	11.98 metres (top of lift overrun)	No contravention proposed
South residential wing (Vicar Street frontage)	12 metres	20.39 metres (top of lift overrun) 21.35 metres (top of roof)	8.39 metres (70%) 9.35 metres (78%)
North residential wing (Vicar Street frontage)	12 metres	16.97 metres (top of parapet)15.80 metres (top of lift overrun)	4.97 metres (41%) 3.80 metres (32%)
North residential wing (Coogee Bay Road frontage)	12 metres	12.00 metres (top of street wall) 15.80 metres (top of lift overrun)	No contravention proposed 3.80 metres (32%)

Table 3 Proposed height variations

Figure 8 to Figure 11 illustrate the proposed breach by the development to the RLEP 2012 height of building standard.

Figure 8 Height plane diagram

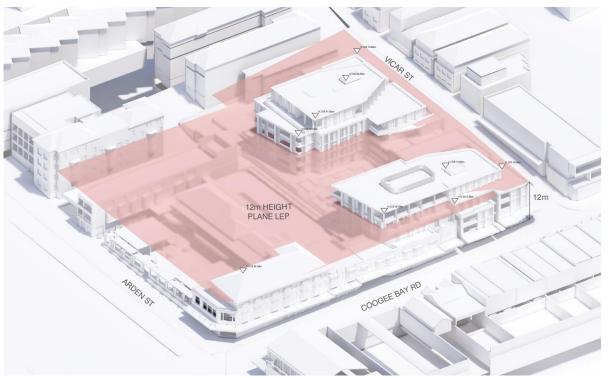

Source: Fender Katsalidis

Figure 9 North Elevation (Coogee Bay Road)



Source: Fender Katsalidis

Figure 10 East Elevation (Arden Street)



Source: Fender Katsalidis

Figure 11 West Elevation (Vicar Street)



Source: Fender Katsalidis

5. RELEVANT ASSESSMENT FRAMEWORK

Clause 4.6 of RLEP 2012 includes provisions that allow for exceptions to development standards in certain circumstances. The objectives of clause 4.6 of RLEP 2012 are:

- (a) to provide an appropriate degree of flexibility in applying certain development standards to particular development,
- (b) to achieve better outcomes for and from development by allowing flexibility in particular circumstances.

Clause 4.6 provides flexibility in the application of planning provisions by allowing the consent authority to approve a DA that does not comply with certain development standards, where it can be shown that flexibility in the particular circumstances of the case would achieve better outcomes for and from the development.

In determining whether to grant consent for development that contravenes a development standard, clause 4.6(3) requires that the consent authority consider a written request from the applicant that seeks to justify the contravention of the development by demonstrating:

- (a) that compliance with the development standard is unreasonable or unnecessary in the circumstances of the case, and
- (c) that there are sufficient environmental planning grounds to justify contravening the development standard.

Clause 4.6(4)(a)(i) requires the consent authority to be satisfied that the applicant's written request adequately addresses each of the matters listed in clause 4.6(3). The consent authority should also be satisfied that the proposed development will be in the public interest because it is consistent with the objectives of the standard and the objectives for development within the zone in which it is proposed to be carried out.

Clause 4.6(4)(b) requires the concurrence of the Planning Secretary to have been obtained. In deciding whether to grant concurrence, subclause (5) requires that the Secretary consider:

- (b) whether contravention of the development standard raises any matter of significance for State or regional environmental planning, and
- (d) the public benefit of maintaining the development standard, and
- (e) any other matters required to be taken into consideration by the Secretary before granting concurrence.

The concurrence of the Secretary can be assumed to have been granted for the purpose of this variation request in accordance with the Department of Planning Circular *PS 20-005 'Variations to development standards'*, dated 5 May 2020. This circular is a notice under section 55(1) of the *Environmental Planning and Assessment Regulation 2021* and provides for assumed concurrence. A consent granted by a consent authority that has assumed concurrence is as valid and effective as if concurrence had been given.

The Secretary can be assumed to have given concurrence if the matter is determined by the Land and Environment Court, an independent hearing and assessment panel or a Sydney district or regional planning panel in accordance with the Planning Circular.

This Request demonstrates that compliance with the maximum building height prescribed for the site in clause 4.3 of RLEP 2012 is unreasonable and unnecessary, that there are sufficient environmental planning grounds to justify the requested variation and that the approval of the variation is in the public interest because it is consistent with the development standard and zone objectives.

In accordance with clause 4.6(3), the applicant requests that the height of building development standard be varied.

6. ASSESSMENT OF CLAUSE 4.6 VARIATION

The following sections of the report provide a comprehensive assessment of the request to vary the development standards relating to the height of building development standard in accordance with clause 4.3 of RLEP 2012.

Detailed consideration has been given to the following matters within this assessment:

- Varying development standards: A Guide, prepared by the Department of Planning and Infrastructure dated August 2011.
- Relevant planning principles and judgements issued by the NSW Land and Environment Court (LEC).

The following sections of the report provide detailed responses to the key questions required to be addressed within the above documents and clause 4.6 of the LEP.

6.1. IS THE PLANNING CONTROL A DEVELOPMENT STANDARD THAT CAN BE VARIED? – CLAUSE 4.6(2)

The maximum building height prescribed by clause 4.3 of RLEP 2012 is a development standard capable of being varied under clause 4.6(2) of RLEP 2012.

The proposed variation is not excluded from the operation of clause 4.6(2) as it does not comprise any of the matters listed within clause 4.6(6) or clause 4.6(8) of RLEP 2012.

6.2. IS COMPLIANCE WITH THE DEVELOPMENT STANDARD UNREASONABLE OR UNNECESSARY IN THE CIRCUMSTANCES OF THE CASE? – CLAUSE 4.6(3)(A)

Historically, the most common way to establish whether a development standard was unreasonable or unnecessary was by satisfying the first method set out in *Wehbe v Pittwater Council* [2007] NSWLEC 827. This method requires that the objectives of the standard be achieved despite the non-compliance with the standard.

This was recently re-affirmed by the Chief Judge in *Initial Action Pty Ltd v Woollahra Municipal Council* [2018] NSWLEC 118 at [16]-[17]. Similarly, in *Randwick City Council v Micaul Holdings Pty Ltd* [2016] NSWLEC 7 at [34] the Chief Judge held that "establishing that the development would not cause environmental harm and is consistent with the objectives of the development standards is an established means of demonstrating that compliance with the development standard is unreasonable or unnecessary".

This Request addresses the first method outlined in *Wehbe v Pittwater Council* [2007] NSWLEC 827. This method alone is sufficient to satisfy the 'unreasonable and unnecessary' requirement.

The Request also addresses the third method, that the underlying objective or purpose of the development standard would be undermined, defeated or thwarted if compliance was required with the consequence that compliance is unreasonable (*Initial Action* at [19] and *Linfield Developments Pty Ltd v Cumberland Council* [2019] NSWLEC 131 at [24]). Again, this method alone is sufficient to satisfy the 'unreasonable and unnecessary' requirement.

 The objectives of the standard are achieved notwithstanding non-compliance with the standard (the first method in Wehbe v Pittwater Council [2007] NSWLEC 827 [42]-[43])


The specific objectives of the height of building development standard as specified in clause 4.3 of RLEP are detailed in **Table 4** below. An assessment of the consistency of the proposed development with each of the objectives is also provided.

Objectives	Assessment
(a) to ensure that the size and scale of development is compatible with the desired future character of the locality,	The desired future character of the locality exists before and informs the establishment of the maximum height for buildings, and the height and scale of developments, in the neighbourhood or area (<i>Woollahra Municipal Council v SJD DB2 Pty Ltd</i> [2020] NSWLEC 115 at [59]). This necessarily means that the desired future character of the neighbourhood or area can be evaluated by reference to matters other than only the provisions of LEP establishing the zoning, the permitted and prohibited development, and the development standards for permitted development in the zone (<i>SJD DB2</i> at [59]). In this case, this means that the desired future character of the locality can be evaluated by reference to matters other than the building height and FSR established by the height and FSR development standards in clauses 4.3 and 4.4 (cf <i>SJD DB2</i> at [59]). The desired future character for a locality can evolve over time, responding not only to the provisions of LEP but also to developments carried out in accordance with development consents granted (<i>SJD DB2</i> at [53]-[54]).
	The Coogee local centre is an established, mixed-use area influenced by Coogee Beach, the iconic heritage item within the site, and Inter-War shop top housing along Coogee Bay Road. The Coogee Local Centre is envisioned in Randwick Local Strategic Planning Statement (LSPS) to transform into an 'Iconic Open Space and Recreation & Tourist Hub'.
	The site plays a significant role in defining an iconic tourist hub identity for the Coogee Local Centre due to its prominent location at the corner of Coogee Bay Road and Arden Street. As noted by Roseth SC [at 22] in <i>Project Venture Developments v Pittwater Council [2005] NSWLEC 191</i> (Project Venture):
	"Compatibility is thus different from sameness. It is generally accepted that buildings can exist together in harmony without having the same density, scale or appearance, though as the difference in these attributes increases, harmony is harder to achieve."
	Roseth SC [at 27] also states:
	'Buildings do not have to be the same height to be compatible. Where there are significant differences in height, it is easier to achieve compatibility when the change is gradual rather than abrupt. The extent to which height differences are acceptable depends also on the consistency of height in the existing streetscape.'
	In order to test whether a proposal is compatible with its context, Roseth SC identifies two questions that should be asked.
	Are the proposal's physical impacts on surrounding development acceptable?
	The proposal's physical impacts on surrounding development are acceptable on the following grounds:
	 Built form has been modulated to step up away from the heritage listed façade with a three storey street wall (ground floor retail with residential

Objectives	Assessment
	above) scale along Coogee Bay Road commensurate with heritage items and contributory buildings in the locality. The street wall has been designed to reflect the 10.5m DCP wall height, and to align with the scale of development to the west of Vicar Street, and along the northern frontage of Coogee Bay Road opposite the subject site.
	 The majority of the façade to Coogee Bay Road is retained, so to ensure continuous presentation of the façade's rhythm and scale to the public domain, including the bay window forms which characterise this façade.
	 The upper level massing is heavily recessed and much smaller than the lower building levels. The fourth floor is set back approximately 6.2 metres with the fifth storey element set back 9.5 metres. Such design characteristics avoid adverse amenity impacts to neighbouring properties in terms of sunlight, privacy, and views.
	 Balconies and apartment layouts are orientated in an east-west layout where possible and oriented to provide casual surveillance to the public domain and minimise privacy impacts on surrounding development.
	 Overshadowing on neighbouring properties is generally caused by the compliant portions of the building envelope.
	 While there are non-compliances with the height control, the overall massing has been developed to ensure the proposed development does not detrimentally impact on any view corridors, as illustrated in the Addendum View Sharing Assessment prepared by Urbis (refer to Appendix A).
	Is the proposal's appearance in harmony with the buildings around it and the character of the street?
	Overall, the proposal has been designed to remain sympathetic to both the heritage character of the Coogee Bay Hotel and relevant DCP controls including the 10.5 metre street wall control. In summary:
	 Building massing associated with the residential component in the western portion of the site has been sensitively located to reflect existing built form massing and ensure adequate visual separation is provided between the heritage listed pub and contemporary elements on site.
	A new wing is proposed on the southern portion of the site fronting Arden Street which reflects the height, scale and form of the original hotel building to the north of the beer garden. The proposed massing visually anchors the site's south east corner and creates a marker to enter the site through the eat street precinct.
	 The development provides well articulated street frontages, comprising a combination of building indentations and modulation to assist with breaking up building form. Heritage façades along Coogee Bay Road are retained and replicated in form to maintain the fine grain character of built form within the Coogee Local Centre (refer to Figure 12). Further, the

Objectives	Assessment
	characteristic bay windows to Coogee Bay Road are retained at this northern façade.
	 Proposed upper residential levels are heavily recessed beyond the 10.5 metre street wall to both Coogee Bay Road and Vicar Street. Such design characteristics avoid adverse amenity impacts to neighbouring properties in terms of sunlight, privacy, and views.
	Overall, the proposed development maintains compatibility with the existing and desired future character, notwithstanding the proposed exceedances of the height control.

Figure 12 Elevation identifying the retention of the fine grain character of Coogee Bay Road

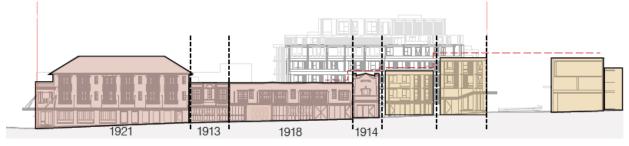

Source: Fender Katsalidis

 (b) to ensure that development is compatible with the scale and character of contributory buildings in a conservation area or near a heritage item, The design of the proposed development has considered the heritage value of the Coogee Bay Hotel, a local heritage item (item 148), and also the general heritage characteristics of the locality. The site is not within a heritage conservation area, however there are a number of built heritage items within the vicinity of the site including:

- 'James Robertson Fountain' located across Arden Street to the east (local item I47),
- 'Sandstone wall' along the length of Coogee Beach to the east (local item I57),
- 'Residential Flat Building' at 101 Brook Street (local item I64) located approximately 100m to the north-west,
- 'Federation House' at 113 Brook Street (local item I67) located approximately 80m to the west,
- 'St Nicolas Rectory' at 123-123A Brook Street (local item I68) located approximately 70m to the south-west, and
- 'St Nicolas Anglican Church' at 125 Brook Street (local item I69) located approximately 90m to the south-west.

Heritage Pub

The existing heritage listed Coogee Bay Hotel building results in a noncompliance with the height control. No change is proposed to the existing roof form of the pub building. As such, the existing non-compliance is compatible with the scale and character of the area and maintains the heritage significance of the site despite the height non-compliance.

Objectives	Assessment
	Residential development
	As outlined in the Heritage Impact Statement that accompanies the DA, the residential component of the building is set behind the north-south alignment of the principal heritage buildings and primary view corridors to the site.
	The non-compliant height provides a built form which allows adequate visual separation between the historic and new forms within the site which ensures the original buildings can be appreciated within the surrounding context. The contemporary design of the development will also deliver a simple backdrop to the heritage buildings, which will retain their prominence within the site.
	The proposed separation ensures the taller element is read as a backdrop to and does not detract from the appearance or prominence of the heritage item from within the site and public views including from the Coogee foreshore (refe to
	Figure 13) and surrounding public reserves such as Dolphin Point.
	Given the heritage buildings within the site will be retained and remain dominant when the site is viewed from the foreshore, the proposal will not alter the existing visual relationship with the James Robertson Fountain and sandstone wall. In addition, the four and five storey elements within the development sit at a lower topography and are physically removed from the other heritage items in the vicinity of the site. The scale and massing of the development is compatible with the mixed character and setting of these heritage items, which include buildings of various heights and ages.

Figure 13 Photomontage of views from Coogee foreshore



Objectives

Assessment

Source: Fender Katsalidis

(c) to ensure that development does not adversely impact on the amenity of adjoining and neighbouring land in terms of visual bulk, loss of privacy, overshadowing and views. The proposal has been designed, positioned and orientated to ensure the additional height does not adversely impact on the amenity of adjoining and neighbouring properties as outlined in the following subsections.

Visual Bulk

The design responds to the location of the existing taller built form elements on site – at the south western corner of the site and stepping down Coogee Bay Road – to ensure that building bulk and view amenity impacts to surrounding residential properties and the public domain are avoided.

In *Britely Property Pty Ltd v Randwick City Council* (No 2) [2020] NSWLEC 1389, in considering an analogous objective, Commissioner Dickson notes (at [103]):

'I am satisfied that the approach required by the test in cl 4.6 of LEP 2012 is not a comparison between the merits of a complying scheme and the proposed scheme to determine if the development achieves the objectives of the standard ...'.

The proposal preserves the visual quality of the Coogee Bay Hotel as an important landmark by retaining the original heritage pub building (despite its existing height contravention). A six metre publicly accessible laneway separates the taller mixed use component which will sit comfortably at the west of the site replacing the current boutique hotel building and other low quality buildings along Vicar Street.

The residential element of the proposal generally maintains the existing two storey street wall along the Coogee Bay Road before stepping up to three storeys at the corner of Vicar Street to create a distinct street corner. The heritage facades of the original pub and Coogee Bay Road are maintained with buildings not considered to have heritage significance towards Vicar Street replaced with contemporary development. The contemporary building has been designed to retain a similar verticality to maintain the streetscape character.

The upper levels above the 10.5 metre street wall are setback then stepped, with a minimum 6.2 metre setback for Level 4 and a 9.5 metre setback at Level 5. Level 5 provides one residential dwelling and rooftop plant areas which are generally located in the location of the existing boutique hotel.

As shown in **Figure 14**, the recess to the upper levels reduces the massing of the building and ensures the proposal does not overwhelm the pedestrian scale of the street. A change in materiality and colour from solid masonry stone and brick clad to zinc sheet defines the upper levels as a light weight structure, independent in massing and design from the lower levels.

Figure 14 Artists impression of Shop Top Housing from corner of Coogee Bay Road and Vicar Street



Source: Fender Katsalidis

The setback areas of the stepped form incorporate private balconies, landscaped roofs and perimeter edge planting which add depth and contrast to the massing of the building to ameliorate visual bulk.

In addition, the development presents as two distinct wings along the western elevation of Vicar Street. The overall design and dual lobbies allow the form to present as two separate buildings when viewed from the street with distinct materiality used for each wing to reflect the changing character from Coogee Bay Road to Vicar Street. Upper level setbacks above the street wall and vertical indents further breakdown the building's interface with Vicar Street and ensures that there is no amenity impact arising from the perception of visual bulk.

Overall, the contravention of the height control does not adversely impact on the amenity of adjoining and neighbouring land in comparison to a compliant built form and maintains a three storey street wall which reflects the intended streetscape character in the Coogee local centre.

Privacy

The proposed shop top housing is setback a minimum of 7.735 metres from the boundary adjacent to the residential building at 17 Vicar Street, with an increased setback at Level 4 and 5 of 13 to 16 metres. This provides adequate building separation in accordance with the requirements of the Apartment Design Guide (ADG). The main living areas and balconies of the southern wing of the development have been oriented east or west and therefore away from 17 Vicar Street.

Objectives	Assessment
	The proposal is separated across Vicar Street from residential dwellings on the western side of the street. The residential dwellings above the 12m height plane will look over the top of the immediately adjacent dwellings to the west and will cause no greater privacy impact than that generated by the existing boutique hotel building presently on the site.
	Privacy amenity impacts to surrounding dwellings have therefore successfully been avoided through building design and the height non-compliance will not detrimentally impact the visual privacy of neighbouring properties.
	In summary, the proposed development does not adversely impact on the amenity of adjoining and neighbouring land in comparison to a compliant built form and provides sufficient separation and acoustic measures to maintain visual and acoustic privacy.
	View Sharing
	A Revised View Sharing Addendum Report (Appendix A) was prepared to inform the overall massing of the proposed development in collaboration between Urbis and ae design partnership.
	As shown earlier in Figure 3 , the site sits in a low central bowl surrounded by sloping topography. The visual catchment is therefore constrained and views to scenic and valuable features from the public domain, including Arden Street, Goldstein Reserve and Coogee Bay would remain unaffected by the proposed development.
	As outlined in the Heritage Impact Statement prepared by Weir Phillips, no significant view corridors to or from nearby heritage items will be impacted by the development and proposed height variation.
	The massing of the building was also informed by detailed view impact analysis and has been prepared following discussions between the applicant and the Council's urban design experts. Overall, the proposed massing represents a collective response to urban design and view issues which seeks to retain access to the most highly valued parts of existing views for the closest and potentially most affected residents.
	This impact analysis informed the location of building massing on the site which responds to:
	The height of the existing boutique hotel
	 View lines to Wedding Cake Island
	 View lines to Dolphin Point
	 View lines to the northern headland of Coogee Beach.
	To inform the Revised View Sharing Addendum Report, 27 dwellings were inspected and views from 18 dwellings were modelled using photomontages (prepared by Urbis) or accurate architectural overlays using survey data (prepared by Fender Katsalidis and ae design partnership).

Objectives	Assessment
	Views were taken from 18 dwellings including representative locations selected and prepared by Urbis (refer to Figure 15). Seven additional views requested by Randwick City Council were prepared by ae design partnership (refer to Figure 16). All these 25 views were analysed in detail and assessed against the principles of <i>Tenacity Consulting v Warringah Council</i> [2004] NSWLEC 140 (Tenacity). The detailed view impact analysis of the proposed built form massing is contained in the View Analysis Assessment enclosed in Appendix A .

Figure 15 Photomontage locations undertaken by Urbis



Figure 16 Photomontage locations undertaken by ae design partnership



Source: Urbis

Given the wide visual catchment investigated as part of the design development for the site, and the resultant assessment of the view impact anticipated to be generated by the proposed building form, the overall visual impacts on neighbouring properties are considered negligible and are acceptable having regard to the level of analysis undertaken to inform the proposed built form. Overall, the view corridor:

- Successfully promotes reasonable view sharing outcomes, as it allows for the retention of south-easterly views to the majority of Wedding Cake Island from close residential dwellings.
- Promotes access to views of open ocean and sea-sky horizon in easterly and north-easterly views.

The views identified in the Revised View Sharing Addendum Report represent the 'worst case' view from identified location, with dwellings generally retaining views to other locations in the locality which will not be impacted by the proposed development.

As noted by Roseth SC [at 26] in Tenacity:

"Whole views are valued more highly than partial views, eg a water view in which the interface between land and water is visible is more valuable than one in which it is obscured."

This is not the case for any of the dwellings inspected, where the majority of views from each dwelling are largely unaffected and the scenic quality of the views are not predominantly characterised by highly valued features as defined in Tenacity.

Objectives	Assessment
	Based on the ratings identified in paragraphs 26-29 of Tenacity, the proposed massing results in nil impacts for two dwellings, negligible or less view impacts for thirteen dwellings, negligible-minor view impacts for seven dwellings, minor view impacts for two dwellings and a moderate view impact for one dwelling.
	It is noted that the seven viewpoints requested for analysis by Council demonstrate no view loss to residents.
	Three dwellings most affected by potential view loss include 5/119 and 1/113 Brook Street (minor) and 17 Vicar Street (moderate) noting that moderate is a mid-range rating using the Tenacity scale.
	5/119 Brook Street (refer to Figure 17)
	The view impact rating is minor when considering all relevant factors including the quantum of view loss, the room types to be affected and availability of other, unaffected views from the whole dwelling and access via the side boundary and compliance with controls. New built form generally replaces existing built form with a minor additional loss of a short section of open water. The non-compliant element of the building largely affects only areas of undifferentiated water and a section of sea-sky horizon . These features are not considered to be scenic or highly valued in Tenacity terms compared to highly scenic whole views. The view impact for the whole dwelling is acceptable in the context of the wider views available, which remain unaffected.
	<u>1/113 Brook Street</u> (refer to Figure 18)
	The view impact rating is minor when all relevant factors are considered. This includes consideration of the quantum and scenic quality of view loss, how the views are obtained and compliance with controls. In Tenacity terms, the view to be lost is not highly valued relative to other types of views identified in the planning principle. The partial view of open undifferentiated water is not part of a whole view that is predominantly characterised by scenic or highly valued feature such as land-water interface, icons or locally known unique features such as Dolphin Point or Wedding Cake Island. All water views (scenic features) that are blocked by massing below the 12 metre height control (and that is to be expected under the planning controls, even with the most skilfully designed building). The additional height sought creates minimal view loss and does not adversely impact this dwelling.
	<u>17 Vicar Street</u> (refer to Figure 19)
	The moderate view impact for 17 Vicar Street is reasonable and acceptable given that it is entirely caused by built form which sits significantly below the LEP height control and is therefore fully compliant with controls that are relevant to view loss. Views to be lost are not considered as scenic or highly valued in Tenacity terms.
	All view loss is caused by massing which complies with the 12 metre

All view loss is caused by massing which complies with the 12 metre height control and sits significantly below it. This view loss will be experienced from a living area and first floor bedroom. Importantly, **no parts**

Objectives	Assessment
	of the additional height sought as part of the Clause 4.6 variation are visible.
	Views across side boundaries are acknowledged as being more difficult to retain by Roseth SC [at 27] in Tenacity. The loss of this partial predominantly characterised by the view loss does not create any significant view loss or view impacts and as such the view sharing outcome is positive, reasonable and acceptable. The partial view of open undifferentiated water is not part of a whole view (that is predominantly characterised by scenic or highly valued feature such as land-water interface, icons or locally known unique features such as Dolphin Point or Wedding Cake Island). To the extent that water views (scenic features) are blocked, it is by massing which is compliant with the LEP height development standard . This loss of view is to be expected under the planning controls, even with the most skilfully designed building. On balance notwithstanding a moderate view impact rating overall, the view sharing outcome is acceptable.
	In summary, when compared to a compliant building height it is demonstrated that:
	 Out of 27 dwelling inspections, potential view loss was modelled for 18 dwellings and rated as minor or less in all cases except for one dwelling.
	 The additional height sought in all views only blocks areas of sky or open water. No additional scenic or highly valued features would be revealed through a further reduction in height.
	In the majority of views analysed (17 out of 18) the overall composition and scenic quality of views will not change significantly as a result of the proposed envelope. The moderate view impact for 17 Vicar Street is reasonable and acceptable given that it is entirely caused by built form which sits significantly below the height control therefore is fully compliant with controls that are relevant to view loss.
	 The visual effects of the proposed envelope are low, the extent of view loss is minor or less for all but one dwelling, the upper and non-complying parts of the proposed envelope predominately block features that are not scenic or combine to form highly valued views as defined in Tenacity.
	Overall, views are maintained from the assessed viewpoints to the key landscape and coastal elements, in a manner commensurate with what would be achieved from a compliant building height (where existing built form elements do not currently exceed these heights). Considering the likely view impacts across the subject site's immediate and wider potential visual catchment, based on the representative views analysed and the low view impact ratings, the proposed development, with its contravention, does not adversely impact on the amenity of adjoining and neighbouring land in terms of views.

Figure 17 Current and proposed views from 5/119 Brook Street



Picture 4 Existing view



Picture 5 Proposed view (the views of undifferentiated water largely impacted by only height-compliant building mass)

Figure 18 Current and proposed views from 1/113 Brook Street



Picture 6 Existing view



Picture 7 Proposed view (only building form that is compliant with the height control is visible)

Figure 19 Current and proposed views from 17 Vicar Street



Picture 8 Existing view

Source: Urbis



Picture 9 Proposed view (only building form that is compliant with the height control is visible)

Overshadowing

Shadow diagrams for the proposed development have been prepared by Fender Katsalidis to address potential overshadowing impacts on adjacent properties. These diagrams demonstrate the following:

- During the morning period, the additional shadows will largely fall over Vicar Street to the west and south-west between 9am to 9.30am. There will be some limited overshadowing to the front setbacks of the residential properties on the western side of Vicar Street, however this is limited to before 9.30am and ensures that there is no material overshadowing to those properties on the western side of Vicar Street at midwinter. Minor additional overshadowing caused by compliant built form impacts the rear communal pen space of both 17 and 19 Vicar Street.
- Between 11am and 2pm, the proposed built form results in a reduction of shadow impacts on 17 Vicar Street with the top level receiving solar access to all windows.
- From 11am onwards, there will be some additional shadows cast over the private open space of 17 and 19 Vicar Street to the south. The additional shadows are offset by the reduction of shadows across both sites at other times.
- Between 1pm and 3pm, the additional shadows will have minor impacts on the communal open space associated with 19 and 21 Vicar Street. The proposal will not adversely impact on the future redevelopment potential of these properties given these are largely unencumbered by shadows during the morning period (9am-12pm).

Further analysis was undertaken to address the potential impacts on 230 Arden Street (refer to **Figure 22**) which is summarised below:

- At 9.00am, four windows are overshadowed compared to the existing built from. It is acknowledged that the additional shadow impact is caused by built form located well below the 12 metre height plane.
- Between 10.00am to 12.00pm, three windows are partially overshadowed by built form which sits well below the 12 metre height plane. The proposed built form results in a reduction of shadows to the rear communal open space improving solar access.
- Between 1.00pm and 2.00pm, two windows are partially overshadowed by built form which sits well below the 12 metre height plane. There is improved solar access to the rear communal area.
- Between 2.00pm and 3.00pm, two windows are partially overshadowed by built form which sits well below the 12 metre height plane. The proposed built form also overshadows a portion of the rear communal area with the majority of the communal area already overshadowed by existing building. This is offset by improved solar access to the western portion of the communal space.

Considering the above, the proposed built form, with the proposed contravention, will not adversely impact on the amenity of adjoining and neighbouring land in terms of overshadowing.

This view is reached based on the analysis carried out for residential properties during the Winter Solstice on June 21. The shadow diagrams indicate that the proposal including non-compliant built form will not result in any additional overshadowing during the Spring Equinox (22 September) or the Autumn Equinox (22 March).


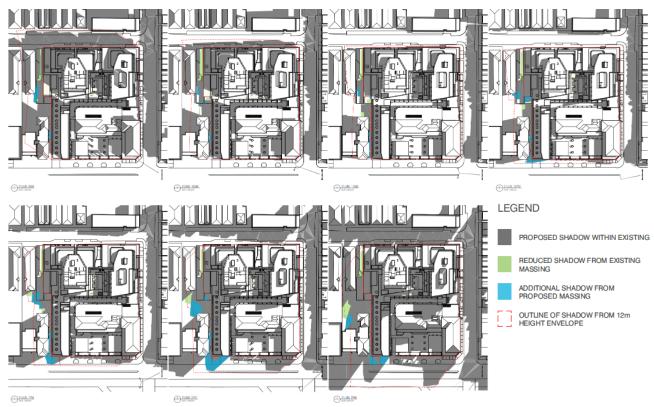


Figure 20 Proposed shadow diagrams for mid winter

Source: Fender Katsalidis

Figure 21 Proposed shadow diagrams for mid winter - Impacts on 17 Vicar Street

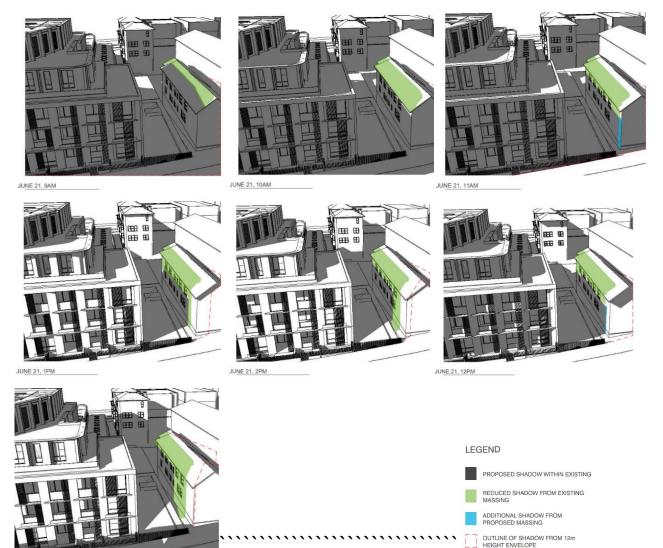

Source: Fender Katsalidis

Figure 22 Proposed shadow diagrams for mid winter - Impacts on 230 Arden Street



Source: Fender Katsalidis

Based on the analysis contained in **Table 4**, the objectives of the development standard are achieved, notwithstanding the non-compliance with the standard.

The underlying object or purpose would be undermined, if compliance was required with the consequence that compliance is unreasonable (the third method in Wehbe v Pittwater Council [2007] NSWLEC 827 [42]-[43] as applied in Linfield Developments Pty Ltd v Cumberland Council [2019] NSWLEC 131 at [24])

Two objectives of the development standard would be undermined if compliance was required.

(b) to ensure that development is compatible with the scale and character of contributory buildings in a conservation area or near a heritage item,

The proposed height non-compliance permits a redistribution of the building mass anticipated by the planning controls away from the Coogee Bay Hotel. This:

- allows for outdoor dining to be retained as well as the expansion of retail and tourism uses on site; and
- maintains a significant portion of heritage fabric along Coogee Bay Road with adequate separation between heritage elements and the four and five storey residential wings towards the west of the site.

The redistribution of building mass maintains the understanding of this heritage item and the contribution that the site makes to Coogee Bay. The design approach respects the heritage components of the site and acknowledges the sense of identity Coogee Bay Hotel presents to the community, present and past.

A design approach that sought to deliver the gross floor area anticipated for the site within in a height compliant envelope would be suboptimal — and would undermine achievement of this objective.

(c) Strict compliance with the standard would likely involve a reduction in the size of the outdoor dining area and/or a reduction (or removal) of the proposed separation between the new building form to the west and the existing Coogee Bay Hotel. The demolition of the non-compliant existing Coogee Bay Hotel roofline would seriously degrade the heritage significance of the hotel and would thwart the achievement of this objective.

to ensure that development does not adversely impact on the amenity of adjoining and neighbouring land in terms of visual bulk, loss of privacy, overshadowing and views.

The proposal will deliver significant public benefits, including the reinvigoration of the iconic pub in a manner that more closely caters to the lifestyle and demands of the local community, significant improvements to the public domain interface of the local centre and delivery of a publicly accessible and vibrant 'eat street' precinct.

By not exploiting the potential height for these portions of the development, there is an improved amenity impact on the adjoining and neighbouring land, in terms of reduced visual bulk.

6.3. ARE THERE SUFFICIENT ENVIRONMENTAL PLANNING GROUNDS TO JUSTIFY CONTRAVENING THE DEVELOPMENT STANDARD? – CLAUSE 4.6(3)(B)

The Land & Environment Court judgment in *Initial Action Pty Ltd v Woollahra Council* [2018] NSWLEC 118, assists in considering the sufficient environmental planning grounds. Preston J observed:

"...in order for there to be 'sufficient' environmental planning grounds to justify a written request under clause 4.6, the focus must be on the aspect or element of the development that contravenes the development standard and the environmental planning grounds advanced in the written request must justify contravening the development standard, not simply promote the benefits of carrying out the development as a whole; and

...there is no basis in Clause 4.6 to establish a test that the non-compliant development should have a neutral or beneficial effect relative to a compliant development"

Strict compliance with the development standard would not deliver any meaningful benefits to the owners or occupants of the surrounding properties or the general public in the particular circumstance of this site and this proposal and would lead to a suboptimal outcome in land use planning terms.

As illustrated in Figure 8 above, there are four areas of height non-compliance.

The south wing

Firstly, there is the south wing, which is located in the south-west corner of the site. The south-wing height non-compliance is illustrated in Figure 23 below.

Figure 23 12 metre height plane of Vicar Street southern wing





Picture 10 Vicar Street southern wing (south east view)

Picture 11 Vicar Street southern wing (north west view)

Source: Fender Katsalidis

The south wing height non-compliance is situated in generally the same location of the existing non-height compliant boutique hotel. The existing 19-metre high boutique hotel is shown (in the context of the whole site) in Figure 7 above. Figure 24 below shows the existing non-compliant height with greater detail.

Figure 24 Existing boutique hotel height-non-compliance





Picture 12 Existing Boutique Hotel (south east view) Picture 13 Existing Boutique Hotel (north west view)


2 SOUTH WING - NORTH WEST VIEW

Source: Fender Katsalidis

The proposed development has — in respect of the south wing non-compliance — been designed to have no material additional adverse impact in terms of visual bulk, loss of privacy, overshadowing and views beyond that caused by the existing boutique hotel (which would be demolished).

Additionally, the boutique hotel is less compatible with the desired future character of the locality than the proposed replacement building form. Vicar Street is currently populated by a loose arrangement of unrelated built form with inactive openings. This is a long frontage and merits a new, active and diverse set of buildings along it. The new built form maintains a 10.5 metre street wall with the fourth floor set back approximately 6.2 metres and the fifth storey element set back 9.5 metres.

Figure 25 Fine grain articulation along Vicar Street

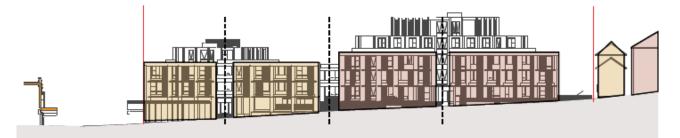

Source: Fender Katsalidis

The overall design and dual lobbies allow the building to present as two separate buildings when viewed from the street with distinct materiality and articulation used for each wing to reflect the changing character from Coogee Bay Road to Vicar Street. The proposal has also been specifically designed with consideration of the importance of the Coogee Bay foreshore public spaces and prominent scenic landmarks including Dolphin Point and Wedding Cake Island. The proposed built form incorporates sandstone and other "natural" materiality to reflect the coastline character and contribute to the scenic quality of the bay.

The demolition of the boutique hotel and its replacement with the proposed new built form that:

- Is more compatible with the desired future character of the locality;
- No less compatible with the scale and character of heritage contributory buildings on the site;
- Has no material additional adverse impact in terms of the visual bulk, loss of privacy, overshadowing and views than the existing boutique hotel; and
- Is of planning benefit to the community.

It is established in the Land and Environment Court that a clause 4.6 request seeking a height variation may be upheld on the basis that the proposed non-compliant form will replace (and is superior to) existing non-compliant form.

In *Cittrus Pty Ltd v Inner West Council* [2019] NSWLEC 1558 Senior Commissioner Dixon considered a clause 4.6 request seeking a height contravention for a new advertising sign that was to replace an existing non-compliant advertising sign. The new sign had a similar scale and was in proportion to the existing building with signage (at [51]). The finish and appearance of the signage was to have a relationship to the associated building design and streetscape. The written request demonstrated that the proposal would not change any important features of the building or existing streetscape and thereby would not dominate the streetscape or skyline (at [51-[52]). The proposal would also remove a roof sign and reduce the existing visual clutter (at [54]).

Importantly, the fact that the proposal was adding visual interest by replacing the existing (non-compliant) out-dated bulky signage format was considered relevant when establishing whether there were sufficient environmental planning grounds to justify the contravention (at [52]). The clause 4.6 request was upheld (at [59] and [97]).

The facts on the south wing aspect of this matter are plainly analogous to those in *Cittrus*. In particular:

- The new south wing has a similar scale and massing to the existing boutique hotel;
- The finish and appearance of the new building fits in well with the streetscape and will have a positive visual impact (relative to the existing non-compliant built form);
- The new building is of a more contemporary (and superior) design and is better adapted to modern needs;
- The south wing component of the building will not dominate the streetscape or skyline; and
- The overall development provides for new modern hotel space on site.

If the height contravention is not approved in relation to the south wing, it will inevitably mean that the existing boutique hotel will remain and the planning benefits from the re-development of this aspect of the site will be lost.

A key justification for the south wing height contravention arises from its replacement of the existing boutique hotel. Nonetheless — even without that existing building form — there are planning benefits in re-massing the development, above the height plane, in the western part of the site.

These planning benefits are two-fold. They relate to heritage and the proposed through-site link ('Selina's Laneway). **Figure 26** and **Figure 27** below shows the proposed relationship between the existing Coogee Bay Hotel (which has significant heritage value) on the eastern part of the site and the proposed new built form on the western part of the site.

Figure 26 Proposed site plan perspective looking east to Coogee Beach



Source: Fender Katsalidis

Figure 27 Proposed site plan perspective looking west



Source: Fender Katsalidis

As the above figures show, parts of the site are kept free of structures (and are therefore not utilising the full extent of the permitted height limit). Significantly, this includes the outdoor dining area on the eastern frontage of the site (a key part of the setting of the Coogee Bay Hotel building) and the proposed open air through-site link (Selina's Laneway).

Even if no allowance was made for the existing boutique hotel (on the western part of the site) it is still desirable to redistribute the building mass provided for the controls above the height plane on the western part of the site, so as to retain the outdoor dining area, create the open air though-site link and ensure an appropriate visual separation between the Coogee Bay Hotel and the new built form on the site.

At this point, it should be noted that there is a separate request for a clause 4.6 contravention in relation to floor space ratio. The key development statistics in relation to gross floor area and floor space ratio are as follows:

Table 5 Proposed FSR variation

	Current Permitted Maximum	Proposed Development	Exceedance	%Exceedance
GFA	12,751.5 sqm	13,488sqm	736.5 sqm	5.8%
FSR	1.5:1	1.59:1	0.09:1	6%

As can be seen from the above, the proposed gross floor area exceedance is 736.5sqm.

Drawing numbers SK125.1-SK125.3 illustrate and provide calculations for:

- proposed gross floor area above the 12-metre height plane generally in the location of the existing boutique hotel;
- proposed gross floor area above the 12-metre height plane to northern wing; and
- existing gross floor area above the 12-metre height plane boutique hotel.

These drawings form part of this clause 4.6 request as Appendix B.

The proposed gross floor area that is contained within the height contravention of the proposed south wing is 1,871sqm. (The detailed material that explains the basis of this figure appears in the floor space ratio clause 4.6 request.)

The proposed floor space exceedance for the whole site is 736.5sqm. The floor space ratio exceedance can, therefore, be **entirely** attributed to 39 per cent of the non-height compliant part of the south wing. (The existing boutique hotel provides for 878sqm in gross floor area above the 12-metre height plane.)

To be clear, only 736.5sqm of additional non-compliant floor area is facilitated by the height contravention. This is less than the 878sqm in gross floor area that is contained within the existing boutique hotel's exceedance of the 12-metre height plane.

The remaining 61 per cent of the gross floor area within the height non-compliant part of the south wing should be viewed as a **redistribution** of **planned** gross floor area (building mass) within the site. In essence, this building mass is being shifted from the eastern part of the site to the west, to ensure an appropriate setting for the Coogee Bay Hotel and the creation of the through-site link.

This redistribution of planned gross floor area:

- allows for outdoor dining to be retained as well as the expansion of retail and tourism uses on site; and
- maintains a significant portion of heritage fabric along Coogee Bay Road with adequate separation between heritage elements and the four and five storey residential wings towards the west of the site.

The redistribution of building mass maintains the understanding of this heritage item and the contribution that the site makes to Coogee Bay. The design approach respects the heritage components of the site and acknowledges the sense of identity Coogee Bay Hotel presents to the community, present and past.

A design approach that sought to deliver the gross floor area anticipated for the site within a height compliant envelope would be suboptimal — and would undermine this objective. It would likely involve a reduction in the size of the outdoor dining area and/or a reduction (or removal) of the proposed separation between the new building form to the west and the existing Coogee Bay Hotel.

The proposed open air through-site link runs central within the site in a north-south direction. The internal streets link Coogee Bay Road and Arden Street, ensuring continual foot traffic and activation through the site. Seven food and beverage offerings service the pedestrian link — creating an eat street precinct.

The through-site link will create a new accessible inclusive public open space for the community. It provides a high-quality public domain for the community.

It should be noted that through-site link is not required by any planning control.

Figure 28 below shows the arrangement of the through-site link 'Selina's Laneway' with digital perspective of the through site link provided in Figure 29.

Figure 28 The arrangement of the through-site link 'Selina's Laneway'



Source: Fender Katsalidis

Figure 29 Artists impression of through-site link 'Selina's Laneway'



Picture 14 Entrance to Eat Street Precinct from Coogee Bay Road



Picture 15 Pedestrian through site link



Picture 16 Arden Street entrance to beer garden and Eat Street Precinct



Picture 17 Vehicle access via Arden Street

Source: Fender Katsalidis

Accordingly, based on the above planning benefits there are sufficient environmental planning grounds to justify the height contravention by the proposed south wing.

The north wing

Secondly, there is the north wing, which is located in the north-west corner of the site. The north wing height non-compliance is illustrated in Figure 30 below.

Figure 30 North wing height-non-compliance



1 NORTH WING - SOUTH EAST VIEW



NORTH WING - SOUTH EAST VIEW

Picture 18 Proposed north wing (south east view)

Picture 19 Proposed north wing (north west view)

Source: Fender Katsalidis

The non-compliant height for the north wing is exclusively a direct result of a re-massing of the building form to:

- Provide adequate visual separation between the heritage buildings and new development within the site;
- Retain the outdoor dining area for the Coogee Bay Hotel; and
- Make the through-site link (Selina's Laneway) possible.

This is because, as discussed above, the separate proposed floor space ratio contravention can be entirely attributed to the south wing contravention (which is, in part, justified by its replacement of the existing boutique hotel).

Accordingly, all of the gross floor area made possible by the north wing contravention is attributable to a sympathetic re-massing of planned gross floor area for the overall site.

The planning benefits outlined (above) for re-massing in relation to the south wing therefore apply in full in relation to the north wing.

The north wing height exceedance should therefore be viewed entirely as a beneficial re-massing within the constraints of the existing permitted gross floor area.

These planning benefits are sufficient environmental planning grounds to justify the height contravention by the proposed north wing.

Coogee Bay Hotel heritage roof

In this part of the height, no additional contravention is proposed. However, it is plainly a planning benefit that the Coogee Bay Hotel heritage item roof be retained, despite its height contravention. The significance of this item is catalogued in the heritage impact statement. This statement forms part of the clause 4.6 request.

These planning/heritage benefit of retaining the Coogee Bay Hotel heritage item roof is sufficient environmental planning grounds to justify the height contravention by that part of the development.

More generally

The benefits the proposed development delivers for the community significantly outweighs any impacts generated by the non-compliance with the maximum height of building control under the RLEP. In any events, there are no material adverse impacts arising from the proposed height contravention (for reasons discussed in section 6.2 above).

Overall, it is considered that strict compliance with the development standard is unreasonable as an alternate scheme which complied with the height standard would result in an inferior outcome for the site. The proposal would need to redistribute gross floor area (**GFA**) to lower levels of the site, which would compromise the protection of the heritage item within the site and proposed through-site link (eat street precinct), which both represent significant public benefit. This would also compromise building separation distances, visual privacy and solar access to residential dwellings within the site which would result in poor amenity for future residents.

The proposed variation will enable the development to deliver the following public benefits:

- The existing Coogee Bay Hotel is an established, well-known destination and the retention and upgrades to this historic landmark will be retained in a more appropriate setting (than when compared with a height compliant development that aimed to realise the planned development intensity for the site).
- Improved pedestrian movement within the block by creating through-block connections including additional connections to Coogee Beach.
- The through-site link (Selina's Laneway) will be a catalyst to revitalise the Coogee local centre and provide a range of economic benefits including:
 - Providing a retail mix that will complement existing shops in the town centre.
 - The eat street concept aligns with Council's aspirations to grow the night-time economy and diversify the food and drink offering in Coogee.
 - Improving the overall town centre retail offer will encourage more people to visit the Coogee local centre and increase activation and amenity.

It is preferable to increase residential densities in-line with the planned level of intensity (with additional residential density in the part of the site occupied by the existing boutique hotel and new hotel wing on the Arden Street frontage) rather than simply under-develop the site. Among other benefits, the increased residential densities proposed on the site will increase the demand for local businesses and services — and therefore generate additional retail spending.

Overall, it is considered that strict compliance with the development standard is a suboptimal environmental planning outcome. The increased height made possible by the contravention reflects the desired future character of Coogee. The Coogee Local Centre is envisioned in Randwick Local Strategic Planning Statement (**LSPS**) to transform into an 'Iconic Open Space and Recreation & Tourist Hub'. The existing Coogee Bay Hotel is an established, well-known destination and the retention and sympathetic upgrades to this historic landmark (made possible by the proposed contravention) will directly benefit the local and broader community and reflect the strategic role of the site within the Coogee town centre.

In brief, the built form (when improvements are compared to the likely compliant built form) better achieves the desired future character for the area and is more consistent with the objectives of clause 4.3 and is a superior outcome for the site when compared with the likely compliant development.

Additionally, the proposed development, notwithstanding the non-compliance with the height of buildings development standard, better achieves important statutory goals (when compared with a complaint development). The superior outcome, in terms of statutory planning goals, combined with the absence of meaningful additional adverse environmental impacts are environmental planning grounds that justify the contravention.

The relevant environmental grounds and the statutory planning goals achieved are as follows:

- The contravention is consistent with the objects of the Environmental Planning and Assessment Act 1979 (EP&A Act):by promoting the orderly and economic use and development of the land and promoting and delivering good design and amenity. This is achieved through the delivery of the through-site link will support new employment in the Coogee Bay local centre. The through-site link will also greatly improve the public domain interface at the heart of the local centre, and in doing so will facilitate a more vibrant village atmosphere to support the local economy. The development, with its contravention, has been designed to distribute bulk and associated height away from the streetscape and heritage items within the site to conserve the local character feel from the pedestrian realm. The proposed distribution of building mass is superior to one that would be necessitated by a compliant development. This achieves the key objectives below:
 - The following objectives of the EP&A Act:
 - Section 1.3(c) to 'promote the orderly and economic use and development of land'.
 - Section 1.3(g) to 'promote good design and amenity of the built environment'.
 - The following aims of the RLEP:
 - Clause 1.2(2)(a) to 'foster a liveable city that is accessible, safe and healthy with quality public spaces and attractive neighbourhoods and centres';
 - Clause 1.2(2)(b) to 'support a diverse local economy and business and employment opportunities for the community';
 - Clause 1.2(2)(c) to 'support efficient use of land, vibrant centres, integration of land use and transport, and an appropriate mix of uses'; and
 - Clause 1.2(2)(d) to 'achieve a high standard of design in the private and public domain that enhances the quality of life of the community'.
- The proposed contravention nonetheless permits a development that achieves the objectives of the development standard prescribed in clause 4.3 of the RLEP, as described in Section 6.2 above and achieves the objectives of the B2 Local Centre zone as described within Section 6.5 below. The proposal seeks to reinvigorate the operation of the Coogee Bay Hotel site and adjacent foreshore by creating a new space for the community with a modern, family friendly focus. It will also provide an opportunity to redevelop the remainder of the site with an intensity and mix of uses that is complementary to the character of this established town centre. The additional building height being sought for the residential component enables the distribution of building mass across the site which provides the opportunity for these objectives to be met. This achieves the key objectives below:
 - The following objectives of the EP&A Act:
 - Sections 1.3(c) and (g) as quoted above; and
 - Section 1.3(f) to 'promote the sustainable management of built and cultural heritage';
 - The following aims of the RLEP:
 - Clauses 1.2(2)(a), (b), (c), (d) as quoted above;
 - Clause 1.2(2)(i) to 'protect and enhance and protect the environmental qualities of Randwick';
 - Clause 1.2(2)(j) to 'ensure the conservation of environmental heritage, aesthetic and coastal character of Randwick;

- Clause 1.2(2)(I) to 'promote an equitable and inclusive social environment'; and
- Clause 1.2(2)(m) to 'promote opportunities for social, cultural and community activities.
- There are unique circumstances at the site which warrant the provision of increased building height, including:
 - The presence of an historic landmark within the site, being the Coogee Bay Hotel, which should be
 protected and afforded adequate building separation to minimise impacts and allow an appreciation
 of this prominent and iconic asset.
 - The significant size of the site, which is positioned along the main street, centrally within the local centre and at a low point of the valley. The distribution of mass on the site affords a contextually appropriate response to a site redevelopment that will see increased activity and functionality, contributing to the Coogee town centre precinct.
 - The existing height non-compliant boutique hotel, which is proposed to be demolished.
 - The existing development consent (DA599/95) which has been physically commenced and provides for the construction of further built form of up to a height of 17.5 metres (see **Figure 4** above). (The proponent commits, if the development consent sought is granted and acted upon, not to construct new works under the existing development consent and to the surrender of the existing development consent prior to the issue of the final occupation certificate for the new development.)
- The proposed development (notwithstanding the non-compliance with the height of buildings development standard) has been carefully designed taking into consideration these unique characteristics of the site to avoid adverse impacts upon the site and its surroundings. This achieves the key objectives below:
 - The objectives in Sections 1.3(c), (f) and (g) of the EP&A Act as quoted above; and
 - The aims in clauses 1.2(2)(d), (i) and (j) of the RLEP as quoted above.
- The additional building height will not result in detrimental environmental impacts in terms of built form, overshadowing, privacy, view or heritage impacts as:
 - The holistic approach to the redevelopment of the site results in an improved relationship between built form on the site and the setting of the heritage item.
 - The proposed development maintains adequate solar access to the surrounding public domain and neighbouring residential properties.
 - The proposed street wall height preserves the integrity of the streetscape and has been designed to
 respond sensitively to the scale, form and materiality of the desired future character. The proposed
 development retains the street corners and addresses the various street frontages and new publicly
 accessible laneway with visually interesting facades.
 - The placement of built form in the areas of existing taller elements within the site results in limited view sharing impacts. Overall, views are maintained from the assessed viewpoints to the key landscape and coastal elements, in a manner commensurate with what would be achieved from a compliant building height (where existing built elements do not currently exceed these heights). Considering the likely view impacts across the subject site's immediate and wider potential visual catchment, based on the 18 representative views analysed and the low view impact ratings, the view sharing outcome is reasonable and acceptable.

As noted above, this promotes good design and amenity of the built form and achieves the key objectives below:

- The objectives in sections 1.3(c) and (g) of the EP&A Act as quoted above; and
- The aims in clauses 1.2(2)(d), (i) and (j) of RLEP as quoted above.
- The contravention will (in comparison with a compliant development) better allow for a mix of proposed residential development that provides additional housing choice suitable for the range of households in the area, including young families, retirees and individuals. This will support a diverse population. The additional GFA facilitates this as well as ensuring that adequate retail and commercial services are also provided to meet the needs of these households. This achieves the key objectives below:

- in the EP&A Act the objectives in sections 1.3(c), (g) and (h) as quoted above; and
- in the RLEP 2012 the aims in
 - clauses 1.2(2)(b), (c), (d), (i) and (j) as quoted above; and
 - clause 1.2(2)(f) to 'facilitate sustainable population and housing growth'; and
 - clause 1.2(2)(g) to 'encourage the provision of housing mix...that meets the needs of people of different ages and abilities in Randwick'.

In summary, there are sufficient environmental planning grounds to justify contravening the development standard.

For completeness we note that the size of the variation (78% at its greatest extent) is not in itself, a material consideration as whether the variation should be allowed. There is no constraint on the degree to which a consent authority may depart from a numerical standard under clause 4.6: *GM Architects Pty Ltd v Strathfield Council* [2016] *NSWLEC* 1216 at [85].

Some examples that illustrate the wide range of commonplace numerical variation to development standards under clause 4.6 (as it appears in the Standard Instrument) are as follows:

- In Baker Kavanagh Architects v Sydney City Council [2014] NSWLEC 1003 the Land and Environment Court granted a development consent for a three storey shop top housing development in Woolloomooloo. In this decision, the Court, approved a floor space ratio variation of 187 per cent.
- In Abrams v Council of the City of Sydney [2019] NSWLEC 1583 the Court granted development consent for a four-storey mixed use development containing 11 residential apartments and a ground floor commercial tenancy with a floor space ratio exceedance of 75 per cent (2.63:1 compared to the permitted 1.5:1).
- In Micaul Holdings Pty Limited v Randwick City Council [2015] NSWLEC 1386, the Land and Environment Court approved a residential flat building in Randwick with a 55 per cent exceedance of the height limit (at its highest point) and a 20 per cent exceedance of the floor space ratio control.
- In SJD DB2 Pty Ltd v Woollahra Municipal Council [2020] NSWLEC 1112 the Court granted development consent to a six-storey shop top housing development with a floor space ratio exceedance of 42 per cent (3.54:1 compared to the permitted 2.5:1).
- In Artazan Property Group Pty Ltd v Inner West Council [2019] NSWLEC 1555 the Court granted development consent for a three storey building containing a hardware and building supplies use with a floor space ratio exceedance of 27 per cent (1.27:1 compared to the permitted 1.0:1).
- In Stellar Hurstville Pty Ltd v Georges River Council [2019] NSWLEC 1143 the Land and Environment Court granted development consent for 12-storey residential tower, on the basis of a clause 4.6 request, with a floor space ratio exceedance of 8.3 per cent.
- In 88 Bay Street Pty Ltd v Woollahra Municipal Council [2019] NSWLEC 1369 the Land and Environment Court granted development consent for a new dwelling house, swimming pool and landscaping at 6 Bayview Hill Road, Rose Bay with a height exceedance of 49 per cent (14.16m compared to the permitted 9.5m.
- In Merman Investments Pty Ltd v Woollahra Municipal Council [2021] NSWLEC 1582, the Court granted a development consent for a residential flat building. In this decision, the Court approve a floor space ratio variation of 85 percent (from 0.65:1 to 1.21:1).

In short, clause 4.6 is a performance-based control so it is possible (and not uncommon) for large variations to be approved in the right circumstances.

6.4. HAS THE WRITTEN REQUEST ADEQUATELY ADDRESSED THE MATTERS IN SUB-CLAUSE (3)? – CLAUSE 4.6(4)(A)(I)

Clause 4.6(4)(a)(i) states that development consent must not be granted for development that contravenes a development standard unless the consent authority is satisfied that the applicant's written request has adequately addressed the matters required to be demonstrated by subclause (3).

Each of the sub-clause (3) matters are comprehensively addressed in this written request, including detailed consideration of whether compliance with a development standard is unreasonable or unnecessary in the circumstances of the case. The written request also provides sufficient environmental planning grounds, including matters specific to the proposal and the site, to justify the proposed variation to the development standard.

6.5. IS THE PROPOSED DEVELOPMENT IN THE PUBLIC INTEREST? – CLAUSE 4.6(4)(B)(II)

Clause 4.6(4)(a)(ii) states development consent must not be granted for development that contravenes a development standard unless the consent authority is satisfied the proposal will be in the public interest because it is consistent with the objectives of the development standard and the objectives for the zone.

The consistency of the development with the objectives of the development standard is demonstrated in **Table 4** above. The proposal is also consistent with the land use objectives that apply to the site under RLEP. The site is located within the B2 Local Centre zone. The proposed development is consistent with the relevant land use zone objectives as outlined in **Table 6** below.

Table 6 Assessment of Compliance with Land Use Zone Objectives

Objective	Assessment
 To provide a range of retail, business, entertainment and community uses that serve the needs of people who live in, work in and visit the local area. 	The proposal includes a range of commercial and residential uses together with an improved hotel and pub offering within the site. The contravention of the height control allows for additional residential development to be provided above the activated ground plane in the location of existing hotel and residential accommodation. The proposal will also result in improved hotel facilities on site and the introduction of a new eat street precinct which provides a through site connection between Coogee Bay Road and Arden Street.
	Overall, the proposal would result in the following benefits:
	 Significant improvement in the range of retail and non-retail facilities that would be available to residents of the Coogee local centre.
	 The proposed development incorporates a limited provision of retail specialty shops and thus residents will continue to frequent other centres/shops in the surrounding area, for a broader retail selection. In addition, the proposed retail specialty floorspace will provide greater choice for residents of Coogee and the surrounding suburbs.
	 The creation of additional employment which would result from the project, both during the construction period, and more importantly, on an ongoing basis once the development is complete and operational.
 To encourage employment opportunities in 	The proposal will facilitate the creation of new jobs within the development, which is close to transport connections to other centres and employment opportunities.
accessible locations.	The height exceedance allows for residential accommodation on site while still allowing for an activated ground floor level fronting the main street of Coogee Bay Road.
	Overall, the proposal will expand upon the existing level of employment provided by the Coogee Bay Hotel and other existing premises. It is anticipated that approximately 90 ongoing jobs will be created as a result of

Objective	Assessment				
	the proposal. It is estimated that an additional 790 jobs will be created indirectly from the proposal.				
	The development will deliver residential accommodation in an area of high accessibility and amenity, as part of a genuine mixed use development. The increased residential densities proposed on the site will increase the demand for local businesses and services.				
 To maximise public transport patronage 	Coogee is a highly accessible local centre within the Randwick LGA. The proposed development provides a mix of uses available for public use.				
and encourage walking and cycling.	The high frequency of buses available on Arden Street frontage provide access to other local and strategic centres and employment hubs including:				
	 370 - Leichhardt via Glebe, Newtown, University of NSW and University of Sydney 				
	 372 - Central Station via Surry Hills and Anzac Parade 				
	 373 - Circular Quay via Elizabeth Street, Oxford Street and Anzac Parade 				
	 374 - Circular Quay via Elizabeth Street, Central Station, Surry Hills and Anzac Parade 				
	 353 - Eastgardens/Bondi Junction via Maroubra 				
	 X73 - Museum Station via Randwick Shopping Centre. 				
	The site's proximity to Coogee Beach and iconic coastal walking tracks including the 6km Bondi to Coogee Coastal Track, encourages walking and active lifestyles.				
	The proposed development seeks to contribute to attractive streetscapes, providing opportunity for walking and cycling. New links and pedestrian connections are proposed through the site including an eat street precinct improving pedestrian connections and activation of the site compared to the current vacant buildings and at-grade parking and loading dock located in the middle of the site. The publicly accessible laneway linking Coogee Bay Road to Arden Street and retail offerings along Coogee Bay Road will provide active frontages with commercial premises to maximise street surveillance and reflect the current character of the area.				
 To enable residential development that is well-integrated with, and supports the primary business function of, the zone. 	Residential accommodation is proposed in the form of shop-top housing. The design is integrated with a mix of uses on site and supports the commercial operation of ground floor tenancies. Introduction of residential accommodation on the site, to the extent proposed, will ensure that the range of employment uses on the site including the Coogee Bay Hotel can continue to operate in a successful and responsible manner, catering to the lifestyle and market demand expected of an operation in this location.				
 To facilitate a high standard of urban design and pedestrian 	The proposal has been designed to respond to the heritage significance of the site and the surrounding streetscape and public domain character, whilst also increasing activation of the ground floor plane. The proposed				

Objective	Assessment
amenity that contributes to achieving a sense of place for the local community.	development retains a two storey street wall reflecting the fine-grained pattern and rhythm of the streetscape along Coogee Bay Road. The design and materiality of the podium facades contribute to the modulated and regular proportioning of shopfronts, which will contribute to the streetscape character and sense of place along Coogee Bay Road. Residential accommodation above the street wall is set back to emphasise the streetscape character of the Coogee village centre.
	Improvements to the public domain interface will be realised along Coogee Bay Road and Vicar Street including the introduction of a publicly accessible laneway and associated eat street precinct. The new 5-6m metre wide laneway will encourage ground level engagement and draw pedestrians into the site. It is intended that the new eat street will provide a new public place for the local community, whilst revitalisation of the pub and beer garden will improve the amenity and experience of pub patrons.
 To minimise the impact of development and protect the amenity of residents in the zone and in the adjoining and nearby residential zones. 	A careful design response has ensured that the proposed development is replacing the existing taller elements in the site. Further, the scale of upper levels has been reduced through increased setbacks, which will result in a reduction in visual impacts on neighbouring properties and from the public domain. The proposed development demonstrates a high level of consistency with the Apartment Design Guide when considering potential impacts to neighbouring residential properties. Where minor variations to numerical standards are proposed, consistency with the relevant objectives have been demonstrated. As highlighted previously, overshadowing and privacy impacts on adjoining properties will be minimised and potential acoustic impacts from the future operation will be ameliorated through the implementation of acoustic screening.
 To facilitate a safe public domain. 	The proposal will deliver a vibrant public domain that is highly accessible for future site users and provides a pedestrian oriented environment with a high degree of permeability. The street frontages and eat street precinct incorporate active retail uses
	which spill out onto the public domain to provide passive surveillance for future uses. The residential apartments located above public domain areas offer additional passive surveillance opportunities.
	The proposal will assist with creating a safer day and night-time environment by removing Selina's night club and transitioning the pub to a more welcoming environment for families. Plans of Management have also been prepared for the publicly accessible laneway, communal open spaces and the existing plan of management for the pub and hotel on site to ensure ongoing safe operation and management of the site.

6.6. HAS THE CONCURRENCE OF THE PLANNING SECRETARY BEEN OBTAINED? – CLAUSE 4.6(4)(B) AND CLAUSE 4.6(5)

The Secretary can be assumed to have concurred with the variation under Department of Planning Circular PS 18–003 'Variations to development standards', dated 21 February 2018. This circular is a notice under 64(1) of the *Environmental Planning and Assessment Regulation 2000*.

The Secretary can be assumed to have given concurrence as the matter will be determined by either the Court or a Sydney district planning panel in accordance with the Planning Circular.

The matters for consideration under clause 4.6(5) are considered below.

Clause 4.6(5)(a) – does contravention of the development standard raise any matter of significance for State or regional environmental planning?

The proposed non-compliance with the height of buildings development standard will not raise any matter of significance for State or regional environmental planning. It has been demonstrated that the proposed variation is appropriate based on the specific circumstances of the case and would be unlikely to result in an unacceptable precedent for the assessment of other development proposals.

Clause 4.6(5)(b) - is there a public benefit of maintaining the planning control standard?

The proposed development achieves the objectives of the height of buildings development standard and the land use zone objectives despite the technical non-compliance.

It is considered that the strict maintenance of the standard in this instance does not have public benefit as the proposal will involve significant improvements to the public domain interface and streetscape character of the Coogee local centre. This could not be achieved by compliance with the height of building standard.

It has been demonstrated that the building can exceed height in certain locations without resulting in adverse impacts on neighbouring properties. The mix of land uses successfully integrated within the site will create a vibrant environment that will revitalise and stimulate the local economy. It is further noted that the proposal will directly generate employment within the area.

There is no material impact or benefit associated with strict adherence to the development standard and there is no compelling reason or public benefit derived from maintenance of the standard.

Clause 4.6(5)(c) – are there any other matters required to be taken into consideration by the Secretary before granting concurrence?

Concurrence can be assumed, however, there are no known additional matters that need to be considered within the assessment of the clause 4.6 variation request.

7. CONCLUSION

For the reasons set out in this written request, strict compliance with the height of buildings development standard contained within clause 4.3 of the RLEP is unreasonable and unnecessary in the circumstances of the case. Further, there are sufficient environmental planning grounds to justify the proposed variation and it is in the public interest to do so.

It is reasonable and appropriate to vary the height of buildings development standard to the extent proposed for the reasons detailed within this submission and as summarised below:

- Compliance with the height of building development standard is unreasonable and unnecessary in the circumstances of the proposed development.
- The proposal, notwithstanding the non-compliance, is consistent with the objectives of the height of building standard and the B2 Local Centre zone.
- There are sufficient environmental planning grounds to justify the contravention, which results in a better planning outcome than a strictly compliant development in the circumstances of this particular case.
- There are unique circumstances arising from the site, with the contravention of the development standard arising as a result of the redistribution of massing to maintain adequate separation and protect the heritage item within the site.
- The proposal will deliver significant public benefits, including the reinvigoration of the iconic pub in a manner that more closely caters to the lifestyle and demands of the local community, significant improvements to the public domain interface of the local centre and delivery of a publicly accessible and vibrant eat street precinct.
- There is an absence of any substantive negative environmental impacts arising from the proposed variation.
- The proposed non-compliance with the height of building standard will not result in any matter of significance for State or regional environmental planning.

For the reasons outlined above, the clause 4.6 request is well-founded. The development standard is unnecessary and unreasonable in the circumstances, and there are sufficient environmental planning grounds that warrant contravention of the standard. In the circumstances of this case, flexibility in the application of the height of buildings development standard should be applied.

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APPENDIX A

REVISED VIEW SHARING ADDENDUM REPORT

COOGEE BAY HOTEL VISUAL IMPACT ASSESSMENT REPORT (PUBLIC AND PRIVATE VIEWS)

PREPARED FOR THE SIMMATTOWN PTY LTD MARCH 2023





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5.0	PUBLIC DOI
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10.0	APPENDICE

APPENDIX 1 - PREPARATION OF PHOTOMONTAGES - URBIS

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APPENDIX 3 - NEIGHBOURING DWELLINGS

EXECUTIVE SUMMARY

This Visual Assessment Report (VAR) follows two previous detailed submissions prepared in relation to a former submitted DA. The previous reports included detailed baseline information, analysis and assessment from public and private view places.

This updated DA includes lower height and smaller scale built forms compared to previous massing versions.

The updated DA is based on an extensive and collaborative design development process as part of an LEC s34 conciliation process reviewed by a number of built form experts and Council officers.

The updated DA also carefully considers and responds to public and private domain views from view places reviewed and agreed by Council.

The series of design changes made over the last 6 months respond to initial feedback provided by Council and the Sydney East Planning Panel in relation to DA 437/2021.

We note that the changes as proposed are also of low visibility in close and medium distant public domain views.

Public domain views have been investigated from parts of Coogee Bay beach, its promenade and Goldstein Reserve.

The visual effects of the updated DA have been modelled and assessed from 5 key public domain locations identified by Council. Please refer to public domain photomontages for further detail.

The updated DA envelope represents a collective response to urban design and view issues which seeks to retain access the most highly valued parts of existing views for the closest and potentially most affected residents.

The updated DA's envelope includes a wide central low section of built form, that is set significantly below the height control and creates a view corridor which allows for the retention of scenic and highly valued views.

The report includes photomontages which show the proposed envelope in views from the 18 residences including representative locations selected and prepared by Urbis and additional views prepared by AE Design requested by Randwick City Council.

The massing model included in existing photographs from potentially affected dwellings, and photomontages have been prepared by Fender Katsalidis and provided to Urbis and AE Design.

AE Design were responsible for preparing supplementary photomontages from additional dwellings as directed by Council. Original photographs used to prepare those images were taken by Urbis from surveyed locations.

Photomontages show complying built form as a red translucent colour and non-complying built form in blue. All non-complying built form proposed is subject to a Clause 4.6 variation application.

The assessment of view loss in individual views and the overall view impact for each dwelling is based on observations made on site at the time of photography and photomontages which are prepared to satisfy the LECNSW requirements for accuracy.

In this regard, the massing shown and the extent of any view loss caused by the built forms proposed, is as accurate as is possible. Therefore the photomontages can be relied upon by the community and consent authorities for assessment and consideration.

27 dwellings were inspected and views from 18 dwellings were modelled using photomontages (prepared by Urbis and AED).

Views from 18 dwellings were analysed in detail and assessed against the Tenacity Planning principle. This includes the original set of views selected by Urbis for analysis and additional views requested by Council.

Conclusions

- Views from all 18 dwellings from the original sample of 27 dwellings inspected, have been modelled to inform this assessment.
- The inclusion of the wide view corridor reduces the visual scale of built form along the length of Vicar Street and will create view sharing benefits to all elevated residential locations immediately west, south-west and north-west of the subject site.
- The view corridor successfully promotes reasonable view sharing outcomes, as it allows for the retention of south-easterly views to the majority of Wedding Cake Island from close residential dwellings.
- The view corridor also promotes access to views of open ocean and sea-sky horizon in easterly and north-easterly views that currently enjoy views to it.
- The views are described in terms of the predominant features present where the selected modelled view represents the 'worse case' view focused on the site, noting that each dwelling has access to other views to the north, north-east and south which do not include the subject site and will not be affected.
- 18 views have been modelled and assessed against the Tenacity Planning Principle to guide our assessment of overall view impacts for each whole dwelling.
- All descriptions and ratings are tabulated in the Tenacity Summary Table (Page 74).

- in Tenacity.
- cases except for one dwelling.
- as a result of the updated DA envelope.
- as defined in Tenacity.
- reasonable and acceptable.
- impact grounds.

 The minor view impact rating is reasonable and acceptable for Brook Street dwellings given that the non-complying parts of the envelope do not block scenic and highly valued features as defined

 The moderate view impact for 17 Vicar Street is reasonable and acceptable given that it is entirely caused by built form which sits significantly below the LEP height control and is therefore fully compliant with controls that are relevant to view loss. Views to be lost are not considered as scenic or highly valued in Tenacity terms.

 In summary out of 27 dwelling inspections, where potential view loss was modelled for 18 dwellings and rated as minor or less in all

 The additional height sought in all views, blocks areas of sky or open water so that no additional scenic or highly valued features would be revealed through a further reduction in height.

In the majority of views analysed (17 out of 18) the overall composition and scenic quality of views will not change significantly

 The visual effects of the proposed envelope are low, the extent of view loss is minor or less for all but one dwelling, the upper and non-complying parts of the proposed envelope predominately block features that are not scenic or combine to form highly valued views

 Considering the likely view impacts for the immediate and wider potential visual catchment, based on the 18 representative views analysed, in our opinion the private views and 5 public views, the predominance of low view impacts and ratings, the outcome is

 View impact ratings for the public domain views are also low. Taking into account all relevant factors and the reasonable sharing of views both for residents, the public and the owners of the subject site, the updated DA can be supported on view sharing and view

1.0 PURPOSE OF THIS REPORT

Urbis has been commissioned by the owners of the existing Coogee Bay Hotel and the applicant to provide independent analysis and assessment of potential view-sharing outcomes in relation to the amended Development Application (pared in April 2022).

The advice has been prepared to provide an assessment of potential visual effects of the proposed development on public domain and private domain views. The lead author of this report specialises in the assessment of visual impacts, view loss, and view sharing assessments and in strategic planning for the protection of scenic resources.

This report follows previous view-sharing advice prepared in relation to a previously submitted and deferred DA for the site. This report was based on two private domain view inspections and additional Computer-generated images (CGIs) to represent views from other neighbouring dwellings.

Relevant parts of the previous report for example, descriptions of baseline factors such as visual context, visual character and potential visual catchment remain relevant and are included.

2.0 BACKGROUND

This report follows previous visual analysis and assessment work undertaken by Urbis and others. The previous view sharing advice was partly informed by preliminary site investigations undertaken by Dr Richard Lamb, engaged by Urbis in 2018. This advice identified the potential visual catchment of the existing built form on the site (based on visibility of the boutique hotel as the tallest built form present on the site) and residential dwellings that would be most at risk of potential view loss should the existing built form on the site change.

In this regard Dr Lamb identified neighbouring locations which based on his fieldwork observations, analysis of the visual context and likely views access, would be those most likely to be potentially affected by view loss. Views from some neighbouring dwellings were recommended for further analysis during the design development stages. Previous work undertaken by Urbis in 2020 and 2021 included consideration of the likely effects on private domain views from two neighbouring dwellings and on other dwellings based on constructed CGI images that were used to indicate likely view sharing outcomes. The DA was referred to the Sydney Eastern City Planning Panel (SECPP) on 16 December 2021, where the SECPP deferred the determination to provide the Applicant the opportunity to address a range of issues, including additional view analysis from affected private properties and the public domain be provided. Council also advised that the view loss from private properties and the public domain is a key issue that needs to be addressed.

Council provided a list of submissions received from properties that raised view loss, either from their own property or the public domain, as a concern.

Response to view loss objections

In response to the 180 objections made in relation to the previous DA which cited view loss or visual impacts, Urbis reviewed and mapped the geographical location of the objector's residences. GIS terrain modelling and LiDar data were used to estimate the highest floor level below the roof ridge height at each residence, in relation to the roof form of the Boutique Hotel. Based on this, Urbis determined that most objectors would either have no or limited access to views of the existing boutique hotel roof or parts of the subject site.

In this way, Urbis could separate more distant locations where although some visibility of the site (the tallest roof) may be visible, it would be highly unlikely to equate to any discernible view loss.

Subsequently, Urbis was able to reduce the scope area to the closest and potentially most affected dwellings, and hand-delivered letters requesting access to approximately 48 premises. In this regard, Urbis narrowed the assessment efforts to dwellings and residential flat buildings located in immediate mid-slope locations to the north-west, west, and south-west.

Views Inspection and identification of view corridors Based on the responses received, Urbis inspected views from 27 individual dwellings. Following analysis of all views inspected we determined that in simple terms, two key view corridors to scenic and highly valued features (as defined in Tenacity) from two general locations. The two key view corridors; are South-east from approximately the intersection at Coogee Bay Road and Brook Street to Wedding Cake Island, and northeast from the vicinity of Brook Street and Kidman Street to Dolphin Point headland and in particular the land-water interface were determined to be worthy of protection. Urbis advised the applicant and consultant team that retaining access to these features and incorporating key view corridors for local residents would be reduced view impacts and improve view sharing outcomes for the majority of residents who have access to the two key view corridors and scenic and highly valued features, for example, Dolphins Point headland and Wedding Cake Island.

The view-sharing outcomes in this report have based analysis of view inspections at 5 public domain locations and inspections at 27 private domain locations. Views towards the site were documented from 27 dwellings and following a review, 12 representative views were selected for further analysis and modelling. The 12 views were used to prepare photomontages which include the revised amended DA and have been used to inform view loss, view impacts, and the overall view sharing outcomes assessed against the Tenacity Planning Principle. Urbis also reviewed and assessed the potential impact the proposal will have on five public domain views. Impact on public views is rated according to the Urbis VIA methodology (refer to figure 2 method flow chart)

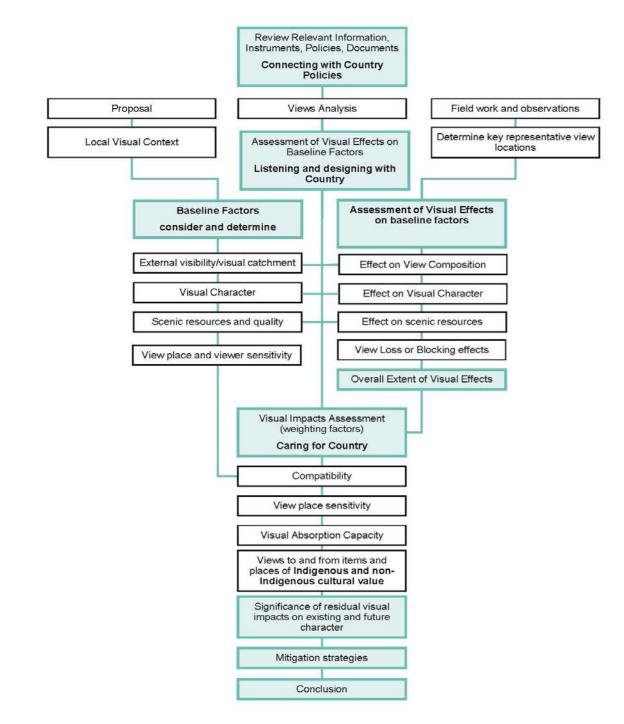


Figure 1 VIA Methodology Flowchart

3.0 PROPOSED DEVELOPMENT

Project Description in Visual Terms

The site is located at 253 Coogee Bay Road, 212 Arden street, 227-233 Coogee Bay Road, 5-7 and 15a Vicar Street. This description reflects the main elements of the proposal that will be visible externally. The existing boutique hotel building at the Vicar Street western boundary will be demolished and replaced by a building that is characterised by a broadly 'C' shaped floorplate.

The key heritage components of the site will be retained, and will remain as visually prominent and distinctive elements in all private and public views inspected. The heritage building at the north-eastern corner of the site is retained where internal changes are not visible externally. We note that the changes as proposed are also of low visibility in close and medium distant views from parts of Coogee Bay beach, its promenade and Goldstein Reserve.

The updated DA architectural set of plans prepared by Fender Katsalidis (February 2023) reflects significant change compared to previous iterations of the design and a previously submitted DA.

Reduced Built Form and View Sharing Corridors

The proposed residential flat building is contemporary in style and includes flat roof forms. The flat roof design extends the built form of the upper storeys to the north and south beyond the existing pitched roof forms, and therefore effectively occupies existing open space.

The setback of the Boutique Hotel will increase the spatial separation between the proposed development and built form along the north side of Coogee Bay road and in so doing widen the view corridor. When considered in easterly views from residences to the west, the proposed envelope will appear as a continuous built form of three storeys which present as low podium form. Above this there are two distinct forms separated by a wide spatial setback.

The northern, taller form includes part of the upper level 4 storey lift overrun which sits above the LEP height control. The wide setback from the 3rd storey roof (above Coogee Bay Road) to the north elevation of the fourth storey and including the wide spatial separation to the southern, taller form, reduce the visual scale of the building. The separation of the two taller forms at the 3rd storey roof level, is in excess of 10 linear metres, creating a generous view corridor and mechanism to promote view sharing.

We note further, than the northern form is characterised by different materialist where the vertical columns are darker in colour compared to the southern lower form. Above level 4 (its 3rd storey) above Vicar Street ground level) the northern form includes wide setbacks to its north and south elevations, so that the form decreases in scale at each storey. The setbacks, separate massing, inclusion of the wide view corridor and differentiated materiality all serve to reduce the perception of visual bulk and scale of the proposal, particularly in easterly views.



Figure 2Site Plan Proposed Fender Katsalidis



NORTH ELEVATION - HERITAGE DETAIL


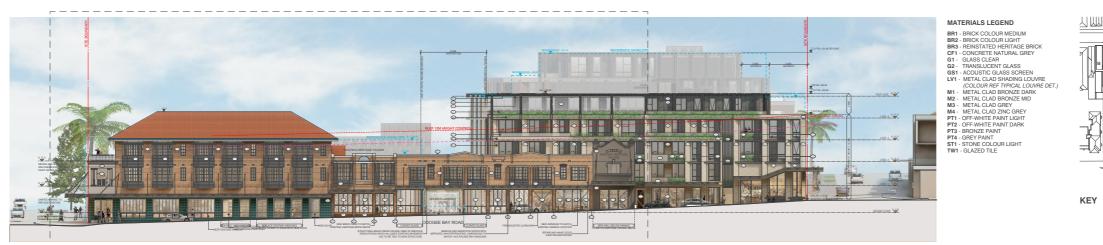


Figure 3 North Elevation Proposed Part 1 Fender Katsalidis



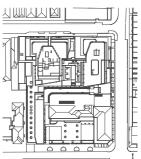

PROPOSED AWNING - PRECEDENT DETAIL

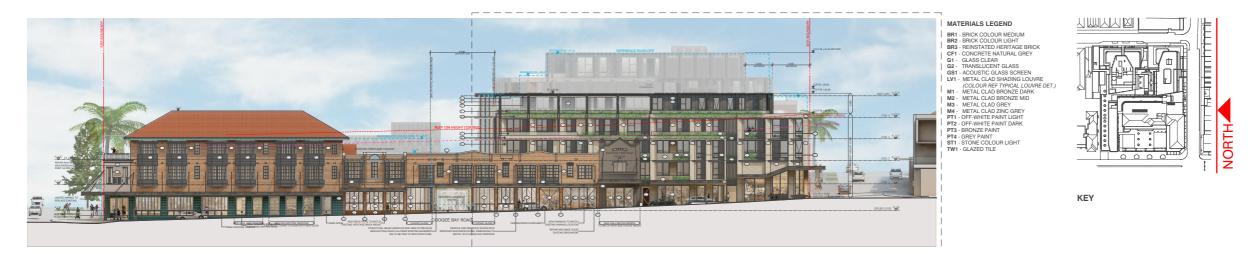


 Figure 4
 North Elevation Proposed Part 2 Fender Katsalidis








Figure 5West Elevation Proposed Part 1 Fender Katsalidis



EAST ELEVATION
 SCALE 1:75@A0



Figure 6East Elevation Proposed Part 1 Fender Katsalidis

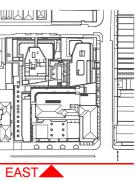


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Figure 7East Elevation Proposed Part 2 Fender Katsalidis



INTERNAL FACE
TYPICALLY LOUVRES WITHIN (Br1) ARE (M1) UNLESS NOMINATED OTHERWISE
FRAMES WITHIN (Br2) ARE (M2) UNLESS NOMINATED OTHERWISE
OPERABLE LOUVRES ON TRACKS TO ALLOW FULL WINDOW COVERAGE OR
STACKING TO EITHER SIDE OF THE WINDOW

LINES ARE FIXED
 TYPICALLY FRAMES WITHIN (Br1) ARE (M1) UNLESS NOMINATED OTHERWISE FRAMES WITHIN (Br2) ARE (M3) UNLESS NOMINATED OTHERWISE
 WINDOW OPENING DIMENSIONS IN MET (FULL SYSTEM)
TRANSLUCENT GLAZING TO BE TYPICAL PRIVACY SCREENING. NOMINATED BY H
 WINDOW GLASS TYPE TYPICALLY G1 UNLESS NOMINATED OTHERWISE

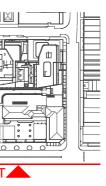


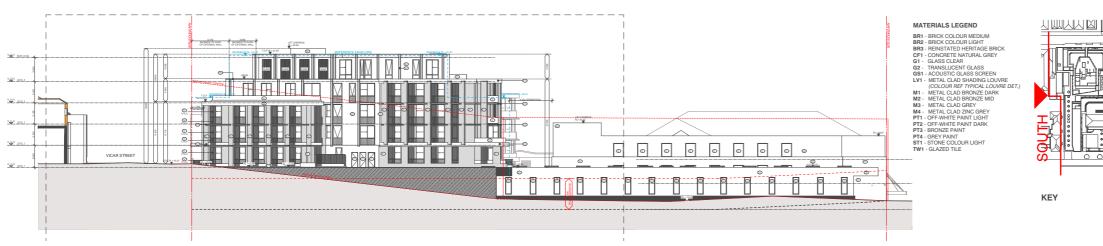


Figure 8 South Elevation Proposed Fender Katsalidis

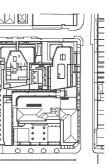

4.0 THE SITE & SURROUNDS

4.1 EXISTING BUILT FORM ON THE SITE

The site comprises 4 allotments, 212 Arden Street, 227-233 Coogee Bay Road, 5-7 Vicar Street and 15A Vicar Street Coogee. The site has a west-east cross fall so that it slopes downwards from Vicar Street towards Arden Street and beyond to Coogee Bay to the east.

The subject site is a prominent 'landmark' site with frontages to Arden Street to the east, Coogee Bay Road to the north and Vicar Street to the south and includes a number of separate buildings, including the eastern heritage buildings (existing hotel premises).

Existing built form on the site includes a heritage building, a boutique hotel, a liquor store, a 2 storey RFB, retail and commercial businesses with shop top housing, and a through site link between Arden Street and Vicar Street on the southern boundary. The buildings range in height with the boutique hotel being the highest at RL 31.47. We observed that built form is concentrated on the eastern, northern and western boundaries, with greater visual permeability through a site link along the southern boundary of the site from Vicar Street to Arden Street.

212 Arden Street at the north-east corner is listed as a Heritage Item, Coogee Bay Hotel, in Schedule 5 of the Randwick LEP. The heritage building presents as a 1920's style hotel. Originally constructed in the late 1800s the building has been significantly altered since its inception. The building is adjacent to another heritage item which is a 2 storey sandstone rectangular building which extends parallel to Arden Street. The Arden Street site frontage includes a beer garden which is relatively open and undeveloped, characterised by moveable furniture such as umbrellas and a row of mature Phoenix Palms. We observed that additional palms are grouped at the south-east edge of the site. The existing hotel has a nil setback to Arden Street and Coogee Bay Road.

1 Vicar Street is a 3 storey shop top housing with a convenience store and restaurants on the ground floor, and two levels of residential apartments above. There is a setback between 1 and 7 Vicar Street which currently has a small parking and bin storage area. 7 Vicar Street is a 2 storey RFB with 4 units and 9 Vicar Street is a late twentieth century boutique hotel.



Figure 9 Existing built form

4.2 BUILT FORM IN THE IMMEDIATE CONTEXT

This description of the immediately surrounding visual context was included in preliminary advice provided by Dr Richard Lamb to the applicant and is replicated here to provide further detail as to the visual setting of the site.

"The streetscape exposure of the site is limited by existing development, the street pattern, with Arden Street forming the east boundary and by the narrowness of Coogee Bay Road and Vicar Street, as the other two bounding streets.

The predominant built form in Vicar Street is interwar to early 20th century residential flat buildings. In Coogee Bay Road, other than on the Site, built form is retail at street level, with shop-top housing of mostly two-storey form other than opposite the hotel at the Arden Street Corner which is slightly higher.

The height of buildings in the vicinity of the site is generally lower than three of the prominent buildings on the site, the taller element of the hotel at the corner of Arden Street and Coogee Bay Road, the boutique hotel on Vicar Street near the south-west corner of the Site and the building on the corner of Vicar Street and Coogee Bay Road on the Site."

The east side of Arden Street is occupied by public open space including Goldstein Reserve which includes an amphitheatre and boardwalk. The public reserve opposite the subject site is relatively open in nature and devoid of built form and characterised by rows of Norfolk Island Palms. The reserve extends to meet a path and retained edge before falling in elevation to meet the beach and further east Coogee Bay beach. Coogee Bay is bordered by the distinctive local headland and rock outcrop known as Dolphin Point to the north and Grant and Trenerry Reserves to the south. At low tide a rock platform known as Wedding Cake Island is visible in the south-east of the bay.



Figure 10 Aerial Site Plan







4.3 STREETSCAPE CHARACTER AND RESIDENTIAL DEVELOPMENT



Photo 1. Coogee Bay Road view east towards Coogee Bay



Photo 2. Coogee Bay Road view to south-east, including heritage buildings on the subject site



west side



Photo 4. Side setback between 1 and 7 Vicar Street, where spatial separation allows views of sky access to the east from parts of Vicar Street



Photo 5. Surrounding residential development, detail of 2 Vicar Street. This dwelling was inspected and views recorded confirm that there is no access to scenic or highly valued views from ground or first floor rooms due to the height and form of intervening development



Photo 6. Detail of 8-10 Vicar Street

Photo 3. View south along Vicar Street to residential development along the



Photo 7. Detail of 12-14 and 18-20 Vicar Street



Photo 8. Detail of 23-25 Vicar Street, south of the site



Photo 9. Detail of 130-132 Brook Street



Photo 10. Detail of 128 Brook Street on the corner of Brook and Kidman Streets



Photo 11. Detail of 122 and 124 Brook Street



Photo 12. Detail of 120 Brook Street



Photo 13. Detail of 117 and 119 Brook Street



Photo 14. View east to 109-111 Brook Street from Kidman Street



Photo 15. Detail of 109-111 Brook Street. We note the presence of evergreen, tree canopies to the east of this development which is likely to limit views access to the east



Photo 16. Side setback between 197 Coogee Bay Road and Adina Apartments at 183 Coogee Bay Road



Photo 17. View south-west from south-eastern corner of subject site



Photo 18. Arden Street streetscape including 230 Arden Street and other 3 and 4 storey and taller hotel development is present



Photo 19. View south-west to subject site from Coogee Bay foreshore



Photo 20. Coogee Bay foreshore view south



Photo 21. View east from centre of Coogee Bay foreshore



Photo 22. View north-west to Dolphin Point from centre of Coogee Bay foreshore



Photo 23. View looking south-east from Dolphin Point towards Crown Plaza on Arden Street



Photo 24. View looking south-east from Dolphin Point towards subject site



Photo 25. Detail view of 11 Kidman Street



Photo 26. Detail view of 28 Kidman Street



Photo 27. 118 Brook Street and the east elevation of residential flat building at 197 CBH behind.



Photo 28. Detail view of residential flat building at 186 Coogee Bay Road from roof top at 201 Coogee Bay Road-



Photo 29. Detail view of 201 Coogee Bay Road



Photo 30. Detail view of 130-132 Brook Street



Photo 31. Detail view of 56 Carr Street



Photo 32. Detail view of 41-43 Carr Street



Photo 33. Detail view of Adrina residential apartments



Photo 34. East block of 14 Kidman Street. Views were inspected from the upper left hand units with easterly view to Coogee Bay



Photo 35. Streetscape view from the corner of Kidman and Brook Streets

4.4 VIEWS FROM THE TRAFFICABLE COMMON AREA ROOF TOP ACROSS THE SITE TO PARTS OF COOGEE BAY AND WEDDING CAKE ISLAND



Photo 36. View south-east to Wedding Cake Island from north-west corner of roof deck at 201 Coogee Bay Road

This is a view from the trafficable common area roof top across the site to Parts of Coogee Bay and Wedding Cake Island. This view was not selected for modelling given that is not a private or public domain location, and views from here are unlikely to be sustained for long periods of time. Views from other parts of the roof to the east and north-east are unaffected by the proposed development.



Photo 37. View east from centre of roof deck at 201 Coogee Bay Road



Photo 38. View east from south end of the roof deck at 201 Coogee Bay Road

5.0 PUBLIC DOMAIN VIEWS

Urbis inspected a wide range of public domain views from various locations within the visual catchment of the subject site. Among those inspected, Urbis were directed to analyse the visual effects and impacts of the proposal on views from 5 key locations. These are presented in the following pages where the proposed built form is modelled for analysis and has been assigned an impact rating following the application of the Urbis VIA method.

In our opinion, viability is not commensurate with a level of visual impact. A visual impact is derived by considering a number of relevant factors such as scale and nature of change, and its compatibility with the existing visual context and character, and desired future character of the area. Also whether the proposed built form would permanently negatively alter the intrinsic scenic quality of the view.



Figure 12 Public Domain View Location Map

VIEW 01 VIEW SOUTH-WEST FROM DOLPHIN PT

Distance class

- Moderate view
- 380m

Existing composition of the view

This view is characterised by the foreground of native coastal planting and a memorial to victims of the 2002 Bali Bombing and midground of Semi-mature Norfolk Island Pine trees and water along the south side of Dolphin Point. Residential flat buildings and the subject site which appear to be approximately equivalent to six residential storeys in height occupy the background view composition.

Visual effects of the proposed development on the composition as modelled

The proposed development is of low visibility and occupies a minor extent of the existing wider view with the development forming one component of the varied background and visual context. The low and separate flat roof forms proposed are compatible with the varied background visual context.

The proposed development does not block important or sensitive views to features of high scenic quality or heritage items. As the proposed development is shown as a simple block-model, its visibility appears heightened when compared with surrounding architectural elements. Once building details including materials, colours and finishes are applied the visual compatibility of the proposed development with its surroundings will increase and therefore reduce its visibility within the visual composition and the potential visual impacts from this location.

Visual effects of proposed development

high
-
Tilgit
high
high
low
high
high
nil
low
low
low



Figure 13 Key Plan of View 2



Figure 14 View 2 - Existing



Figure 15 View 2 - Proposed

VIEW 02 VIEW FROM DOLPHIN POINT ROCK PLATFORM

Distance class

- Moderate view
- 350m

Existing composition of the view

This view is characterised by the foreground composition of Giles Baths, Coogee Bay, rock outcrops, Coogee Beach and Goldstein Reserve. The existing heritage buildings on the subject site are visible through gaps in vegetation where the boutique hotel is partially screened by intervening vegetation. Residential development, and larger built forms such as the Crowne Plaza are visible across the mid-slope locations above and south of the site. The view is characterised by significant beach side and ridgeline vegetation.

Visual effects of the proposed development on the composition as modelled

The upper levels of the proposed development will be visible from this location, with the Coogee Bay Hotel and Norfolk Pine trees within Goldstein Reserve filtering elements of the proposal. The proposal will block a minor extent of background residential development and when considered in the broader context, the change in form when viewed within the wider context does not significantly alter the predominant visual character or composition of the view and does not block important or sensitive views to features of high scenic quality or heritage items. We note further that visibility of the proposed development as shown in a simple block-model will be reduced following the application of materials, colours and finishes. These fine-grained details will increase the visual compatibility of the form and scale proposed and reduce the level of potential visual impacts from this location.

Visual effects of proposed development

Overall visual impact rating	LOW							
Compatibility/compatibility with regulatory framework and DCP objectives	low							
Compatibility with Urban Context and Visual Character	high							
Visual Absorption Capacity	high							
Public Domain View Place Sensitivity	high							
Rating of visual effects on variable weighting factors								
View Loss & View Blocking Effects	low							
Viewing Distance	high							
Viewing Period	high							
Viewing Level	nil							
View Composition	low							
Scenic Quality of View	low							
Visual Character	low							
visual encets of proposed development								



Figure 16 Key Plan of View 2



Figure 17 View 2 - Existing



Figure 18 View 2 - Proposed

VIEW 03 VIEW FROM GOLDSTEIN RESERVE

Distance class

- Moderate view
- 340m

Existing composition of the view

This view is predominantly characterised by open space, vegetation, parts of Coogee Beach and distant residential development and building development across the lower slopes of South Coogee. The beach side row of Norfolk Island screens the majority of Coogee Bay Hotels heritage buildings; where parts of the roof forms remain visible among other pitched and gabled roof forms which character the immediate surrounds.

Visual effects of the proposed development on the composition as modelled

The proposed development introduces a minor extent of new built form into the view which replaces a small amount of visible built-form beyond the site. The proposed development contributes favourably to the existing visual context that is characterised by varying scale and architectural styles and does not block views to features of high scenic quality or to heritage items.

As a result of the proposed development sitting within a wider view of development, the visual composition remains largely unaffected. The proposed development is shown as a simple block-model where the visual effects of the built form would be less if considering its finished materials and colours.

Building details including materials, colours and finishes increase visual compatibility of the proposed development with its surroundings, therefore reducing its visual impact.

Visual effects of proposed development

Overall visual impact rating	LOW	
Compatibility/compatibility with regulatory framework and DCP objectives	low	
Compatibility with Urban Context and Visual Character	high	
Visual Absorption Capacity	high	
Public Domain View Place Sensitivity	high	
Rating of visual effects on variable weighting factors		
View Loss & View Blocking Effects	low	
Viewing Distance	high	
Viewing Period	high	
Viewing Level	nil	
View Composition	low	
Scenic Quality of View	low	
Visual Character	low	
visual effects of proposed development		



Figure 19 Key Plan of View 3



Figure 20 View 3 - Existing



Figure 21 View 3 - Proposed

VIEW 04 VIEW FROM GOLDSTEIN RESERVE (PUBLIC PLAZA)

Distance class

- Close view
- 40m

Existing composition of the view

The view from Goldstein reserve onto the intersection of Arden Street and Coogee Bay Road is predominantly characterised by public space and streetscape along Coogee Bay Road. The heritage buildings of the Coogee Bay Hotel are visually prominent and provide a local visual focal point along the Coogee Bay frontage.

Visual effects of the proposed development on the composition as modelled

The majority of the view is unaffected by the proposal, with the Coogee Bay Hotel and public open space remaining the dominant visual features. The proposed built form is of low visibility from this view place where its additional height cannot be easily perceived. The level of visual effects will be further reduced considering the application of materials and colours, making the flat roof form and massing visually compatible.

The proposal does not visually dominate, or block views to the heritage items on the site or to other important local features. The updated DA massing, form and scale make no significant change to the scenic quality or visual character of this view or others which may be available in the vicinity of the site.

Overall visual impact rating	LOW	
Compatibility/compatibility with regulatory framework and DCP objectives	low	
Compatibility with Urban Context and Visual Character	high	
Visual Absorption Capacity	high	
Public Domain View Place Sensitivity	high	
Rating of visual effects on variable weighting factors		
View Loss & View Blocking Effects	low	
Viewing Distance	low	
Viewing Period	low	
Viewing Level	nil	
View Composition	low	
Scenic Quality of View	low	
Visual Character	low	
Visual effects of proposed development		



Figure 22 Key Plan of View 3



Figure 23 View 2 - Existing



Figure 24 View 2 - Proposed



VIEW 05 VIEW EAST FROM THE INTERSECTION OF MOUNT STREET AND COOGEE BAY ROAD

Distance class

- Moderate view
- 340m

Existing composition of the view

This view is characterised by the Coogee Bay Road streetscape to the east which falls in elevation towards the beach. The subject site and existing Coogee Bay Hotel is of low visibility from this distant location. A narrow section or ocean vignette is visible above the view corridor. This is a vernacular public domain view devoid of any high scenic quality or unique values.

Visual effects of the proposed development on the composition as modelled

The proposed development is of low visibility from this view place, as a result of existing vegetation and buildings visible along Coogee Bay Road. A minor extent of the northern facade of the proposal will be introduced to this view composition, however does not block elements of high scenic quality.

Building details including materials, colours and finishes will further increase the visual compatibility of the proposed development with its surroundings and reduce its overall visibility, and impact on this view composition.

Visual effects of proposed development								
Visual Character	low							
Scenic Quality of View	low							
View Composition	low							
Viewing Level	nil							
Viewing Period	low							
Viewing Distance	high							
View Loss & View Blocking Effects	low							
Rating of visual effects on variable weighting factors	Rating of visual effects on variable weighting factors							
Public Domain View Place Sensitivity	low							
Visual Absorption Capacity	high							
Compatibility with Urban Context and Visual Character	high							
Compatibility/compatibility with regulatory framework and DCP objectives	low							
Overall visual impact rating	LOW							



Figure 25 Key Plan of View 5



Figure 26 View 2 - Existing



Figure 27 View 2 - Proposed



6.0 PRIVATE DOMAIN VIEWS

The site sits in a low central 'bowl' surrounded by sloping topography which rises to the south, west and north. In this regard surrounding residential development springs from a similar or higher natural ground level relative to existing and proposed built forms on the site. This situation is likely to facilitate views access towards and across the site.

The private domain visual catchment in relation to the site, based on the external visibility of the tallest built form (boutique hotel roof form) is limited and constrained to immediate areas within Coogee Bay. This extent of visibility (visual catchment) has been tested using Lidar Data Mapping as shown in Figure 35 and 36 and includes residential development west, north-west and south-west of the subject site.

Residential development surrounding the site is predominantly characterised by two to three storey residential flat buildings, isolated individual two storey dwellings and shop top housing on Coogee Bay Road.

Our assessment of likely view access is based on our fieldwork observations regarding relative heights, orientation, window and balcony placement and spatial separation between buildings.

Analysis of images taken from Dolphin Point towards the site highlighted residential lots on Vicar and Brook Streets that may have potential views to the proposed development and beyond to notable scenic features including Dolphins Point and Coogee Bay.

We have inspected views from 27 dwellings within immediate visual context. Viewplace locations are shown at Figure 28.

URBIS PHOTOMONTAGE VIEW LOCATIONS



Figure 28 View location map

VIEW PLACE 8 - 1/113 BROOK STREET EXISTING VIEW



Figure 29 Existing view east from 1/113 Brook Street

This view is from the main open-plan living room which occupies the length of the east elevation of this dwelling. Notwithstanding the dwelling is single storey, the views are available from a height that is approximately equivalent to one residential storey above natural ground due to the underlying topographical cross-fall. The view composition is predominantly characterised by foreground vegetation and residential development including dwellings at 14 and 16 Vicar Street. A short section of the distant background between roof forms includes open, undifferentiated water and sea-sky horizon. Open undifferentiated water although 'scenic' in nature, in isolation and as a partial view is not considered as highly valued in *Tenacity* terms. No other views are available from this dwelling that will be affected by the proposed development.

PROPOSED VIEW



Figure 30 Proposed view from 1/113 Brook Street. No other views to the east are available from this dwelling.

All of the scenic features in the view are blocked by the lower height and complying parts of the proposed built form. The majority of the built form proposed is located to the north and is heavily screened by dense evergreen vegetation located in neighbouring properties.

Dwelling Address	Description	Photomontage number	<i>Tenacity</i> Step 1, Existing views to be affected?	<i>Tenacity</i> Step 2, From where are the views available?	<i>Tenacity</i> Step 3, Extent of view impacts for whole dwelling (consider room type and use and unaffected views)	Steps in <i>Tenacity</i> - where threshold test is met	Step 4 - summary statement, reasonabler
1/113 Brook Street	Single storey	View Place 8	A minor part of the view	Views are gained	Minor	1,2,3	The view impact rating is minor when all r
	Federation style		includes a partial water	across a rear boundary,			consideration of the quantum and scenic c
	semi-detached villa.		view which is considered	where access to			and compliance with controls. Notwithsta
			to be of some value in	such views should			valued by the resident, in Tenacity terms t
			Tenacity terms.	be considered for			types of views identified in the planning pr
				retention, views are			water, is not part of a whole view that is pr
				gained from standing			feature such as land-water interface, icon
				positions where more			Point or Wedding Cake Island. All water v
				limited views are			parts of the proposed development. The a
				available from seated			variation application, creates minimal view
				positions.			dwelling. The view sharing outcome is rea

Figure 31 Tenacity Table Summary



leness in the context of non-compliance.

I relevant factors are considered. This includes c quality of view loss, how the views are obtained etc standing that access to the partial water view may be s the view to be lost is not highly valued relative to other principle. The partial view of open undifferentiated predominantly characterised by scenic or highly valued ons or locally known unique features such as Dolphin r views (scenic features) are blocked by lower complying e additional height sought as part of the Clause 4.6 iew loss and no significant amenity impacts for this easonable and acceptable.

VIEW PLACE 9B - UNIT 19, LEVEL 5, 183 COOGEE BAY ROAD EXISTING VIEW



Figure 32 Existing view east from unit 19 living room's balcony - level 5 - 183 Coogee Bay Road

This is an easterly view from the east edge of a wide balcony associated with living areas. The foreground of the view is characterised by pitched and flat roof forms of 118 and 120 Brooke Street. The midground composition predominately includes residential dwellings in Brook Street, the existing Coogee Bay Boutique hotel and some vegetation, including the upper parts of the beach side Norfolk Island Pine Trees which indicate the edge of Goldstein Reserve. The background distant view includes open water in Coogee Bay, a section of Wedding Cake Island when available at low tide and a wide section of sea-sky horizon.

PROPOSED VIEW

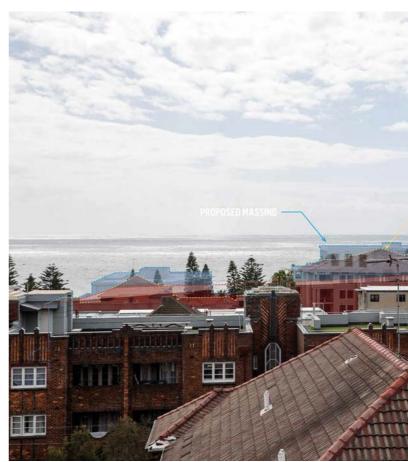


Figure 33 Proposed view

There is no change to the foreground composition or spatial arrangement of built forms in close views. The proposed development introduces a new built form into the mid-ground composition and replaces part of the existing built forms on the site, occupying space which is currently under-developed. The lower complying parts of the proposed development will block a narrow horizontal section of the view including parts of the beach side tree canopy and open water within and beyond Coogee Bay. The additional height sought as shown in blue rises to a height approximately defined by the existing boutique hotel ridgeline and extends to the north and south beyond this existing roof form, to block a minor extent of open and undifferentiated water and some beach-side vegetation. The non-complying upper parts of the proposed development do not block locally significant visual features such as Wedding Cake Island or Dolphin Point. The non-complying upper parts of the proposed development do not dominate the view, significantly alter the scenic quality of the whole view and create a minor extent of view loss. The composition to be lost is not considered as iconic, scenic or highly valued in isolation or a 'whole view' the meaning and formation of which is described in *Tenacity*.



ANCE TO PROJECT

ADDITIONAL VIEWS AVAILABLE FROM UNIT 19, LEVEL 5, 183 COOGEE BAY ROAD



Existing view north from unit 19 living room's balcony -Photo 39. level 5 - 183 Coogee Bay Road





Photo 40. Existing view northeast from unit 19 living room's level 5 - 183 Coogee Bay Road balcony -

Dwelling Address	Description	Photomontage number	<i>Tenacity</i> Step 1, Existing views to be affected?	<i>Tenacity</i> Step 2, From where are the views available?	<i>Tenacity</i> Step 3, Extent of view impacts for whole dwelling (consider room type and use and unaffected views)	Steps in <i>Tenacity</i> - where threshold test is met	Step 4 - summary statement, reasonableness in tl
19/183 Coogee Bay Road	Level 5, east facing unit within the Adina Apartment development.	View Place 9B	The view to be lost includes vegetation, building development and areas of open water, features that are of some value as defined in <i>Tenacity</i>	Standing and seated views over a formal side boundary. We acknowledge that this is considered as a primary view from the dwelling by the resident.	Negligible-minor	1,2,3	The view impact is negligible due to the limited ex hotel roof form. The limited extent of view loss occ parts of an expansive balcony and living areas. The unaffected by the non-complying built from propo valued features such as whole views formed by w unique features such as Dolphins Point or Wedding additional height sought as part of the Clause 4.6 v significant amenity impacts for this dwelling. A re reveal more scenic or highly valued features and v view sharing outcome is reasonable and acceptab

Figure 34 *Tenacity* assessment table

Existing view east from unit 19 living room's balcony level 5 - 183 Coogee Bay Road

extent of view loss created either side of the Boutique occurs within a much wider view available from some The majority of the wide arc of view available will remain posed where views to be lost do not include highlywater and land-water interface, icons or locally known ling Cake Island. The proposed development, including the .6 variation application, creates minimal view loss and no reduction in height to meet the LEP control would not d would not significantly reduce amenity impacts. The able.

VIEWPLACE 9A - UNIT 21, LEVEL 5, 183 COOGEE BAY ROAD EXISTING VIEW



Figure 35 Existing view east from unit 21 balcony - level 5 - 183 Coogee Bay Road

This is an easterly view from the east edge of a wide balcony associated with living areas. The foreground of the view is characterised by pitched and flat roof forms of 118 and 120 Brooke Street. The mid-ground composition predominately includes residential dwellings in Brook Street, the existing Coogee Bay Boutique hotel and some vegetation, including the upper parts of the beach side Norfolk Island Pine Trees which indicate the edge of Goldstein Reserve. The background distant view includes open water in Coogee Bay, a section of Wedding Cake Island when available at low tide and a wide section of sea-sky horizon

PROPOSED VIEW

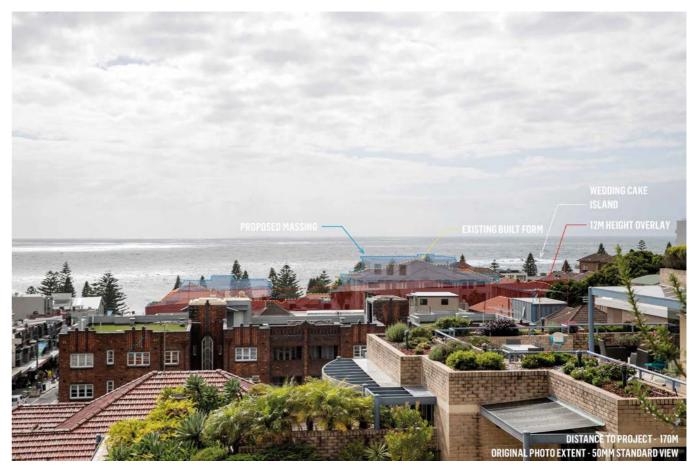


Figure 36 Proposed View

There is no change to the foreground composition or spatial arrangement of built forms in close views. The proposed development introduces two separate low forms into the mid-ground composition and replaces part of the existing built forms on the site, occupying space which is currently under-developed. The lower complying parts of the proposed development will block a narrow horizontal section of the view including parts of the beach side tree canopy and open water within and beyond Coogee Bay. The two forms are spatially well separated creating a wide view corridor, which reduces the perception of bulk and scale of the proposal.

The additional height sought as shown in blue rises to a height defined approximately by the existing boutique hotel ridgeline and extends to the north and south beyond this existing roof form, to block a minor extent of open and undifferentiated water and the upper canopy of some beach-side vegetation. The non-complying upper parts of the proposed development do not block locally significant visual features such as Wedding Cake Island or Dolphin Point. The non-complying upper parts of the proposed development do not block locally significant visual features such as Wedding the view, significantly alter the scenic quality of the whole view and create a minor extent of view loss. The composition to be lost is not considered as iconic, scenic or highly valued in isolation or a 'whole view' the meaning and formation of which is described in *Tenacity*.




ADDITIONAL VIEWS AVAILABLE FROM UNIT 21, LEVEL 5, 183 COOGEE BAY ROAD



Photo 42. View east from unit 21 balcony - level 5 - 183 Coogee Bay Road



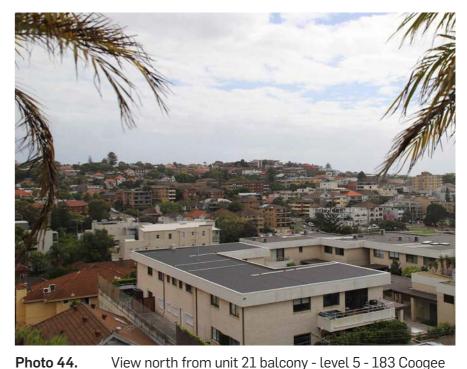

View northeast from unit 21 balcony - level 5 - 183 Photo 43. Coogee Bay Road

Bay Road

Dwelling Address	Description	Photomontage number	<i>Tenacity</i> Step 1, Existing views to be affected?	<i>Tenacity</i> Step 2, From where are the views available?	<i>Tenacity</i> Step 3, Extent of view impacts for whole dwelling (consider room type and use and unaffected views)	Steps in <i>Tenacity</i> - where threshold test is met	Step 4 - summary statement, reasonableness in th
21/183 Coogee Bay Road	Level 5, east facing unit within the Adina Apartment development.	View Place 9A	The view to be lost includes vegetation, building development and areas of open water, features that are of some value as defined in <i>Tenacity</i>	Standing and seated views over a formal side boundary. We acknowledge that this is considered as a primary view from the dwelling by the resident.	Negligible-minor	1,2,3	The view impact is negligible due to the limited ex- hotel roof form. The limited extent of view loss occ parts of an expansive balcony and associated living will remain unaffected by the non-complying built highly-valued features such as whole views forme known unique features such as Dolphins Point or W including the additional height sought as part of the loss and no significant amenity impacts for this dw would not reveal more scenic or highly valued feat amenity. The view sharing outcome is reasonable a

Figure 37 *Tenacity* assessment table

View north from unit 21 balcony - level 5 - 183 Coogee

extent of view loss created either side of the Boutique occurs within a much wider view available from some ving areas. The majority of the wide arc of view available uilt from proposed where views to be lost do not include ned by water and land-water interface, icons or locally Wedding Cake Island. The proposed development, the Clause 4.6 variation application, creates minimal view dwelling. A reduction in height to meet the LEP control eatures and would not significantly improve views or le and acceptable.

VIEW PLACE 14B - UNIT 5, LEVEL 3, 180-186 COOGEE BAY ROAD **EXISTING VIEW**

PROPOSED VIEW



Figure 38 Existing view east from unit 5 balcony - level 3 - 180 Coogee Bay Road

This is a north-easterly view from a level three unit balcony, associated with kitchen and living areas. The balcony extends along the entire east and south elevation of the unit, offering expansive views to the north, north-east, and south. The composition is predominantly characterised by a foreground and mid-ground of development including two to four storey buildings. The upper parts of the existing boutique hotel are visible to the south-east. The distant mid-ground and back ground include the Norfolk Island tree canopies along Goldstein Reserve promenade, which filter views of Wedding Cake Island and the wide section of open undifferentiated water and sea-sky horizon beyond.

Figure 39 Proposed view - including view corridor below the LEP height control to maintain views to Wedding

There is no change to the foreground composition or spatial arrangement of built forms in close views. The central low part of the built form proposed sits significantly below the LEP height control and creates a view corridor through which access to Wedding Cake Island is retained. The view corridor has been designed for this purpose between the northern and southern taller forms, where the resultant re-massing has been located north and south to increase the height of built form above the height control. The additional height sought either side of the designed view corridor blocks a minor amount of open water and vegetation. The additional height sought as shown in blue rises to a height approximately defined by the existing boutique hotel ridgeline and extends to the north of the view corridor blocking a short central section of sea-sky horizon and open areas of sky. We note that sections of sea-sky horizon will be retained within the central view corridor and to the north. The non-complying upper parts of the s34 proposed envelope do not block locally significant features and as such views to be lost are not considered to be iconic, scenic or highly valued in isolation or a 'whole view' the definition of which is described in *Tenacity*. The wider views available to the north-east, north, south and west from this dwelling including to Dolphins Point and Dunningham Reserve are unaffected by the proposed development.





ADDITIONAL VIEWS AVAILABLE FROM UNIT 5, LEVEL 3, 180-186 COOGEE BAY ROAD



Photo 45. View east from unit 5 living room - level 3 - 180 Coogee Bay Road





View northeast from unit 5 dinning room balcony - level Photo 46. 3 - 180 Coogee Bay Road

Photo 47.

Dwelling Address	Description	Photomontage number	<i>Tenacity</i> Step 1, Existing views to be affected?	<i>Tenacity</i> Step 2, From where are the views available?	<i>Tenacity</i> Step 3, Extent of view impacts for whole dwelling (consider room type and use and unaffected views)	Steps in <i>Tenacity</i> - where threshold test is met	Step 4 - summary statement, reasonableness in th
Unit 5 180-186	Level 3 top floor	View Place 14B	Views affected include a	Views are obtained	Minor -negligible for	1,2,3	The view impact rating is minor-negligible, when a
Coogee Bay Road,	unit located at the		partial view characterised	across the formal	the whole dwelling.		consideration of the quantum and quality of view lo
Coogee	north-east edge of		by scenic features	side boundary of			the proposed development. The parts of the dwelli
	this residential flat			this residential flat			side boundary and the wider and unaffected views
	building. The unit			building, which has a			all of Dolphins Point headland which are unaffected
	presents elevations			formal presentation			of the south-easterly view to Wedding Cake Island
	to the east and south			to Coogee Bay Road.			and built form that sits significantly below the LEP
				We acknowledge that			
				this is considered			The non-compliant upper parts of the built form pr
				as a primary view			and predominantly block a minor amount of undiffe
				from the dwelling by			the LEP height control would not reveal more scen
				the resident. Views			would not significantly improve views or amenity. T
				are available from			acceptable.
				standing and some			
				seated positions on the			
				balcony and within the			
				dwelling.			

Figure 40 Tenacity assessment table

View east from unit 5 dinning room's balcony - level 3 -180 Coogee Bay Road

all relevant factors are considered. This includes loss caused by the lower and fully complying parts of elling from which views are affected are accessed via the vs available to scenic compositions including for example ted by the proposed development. The most scenic parts nd are retained due to the inclusion of a 'view corridor' EP height control.

proposed do not block views to highly-valued features fferentiated water and sky. A reduction in height to meet enic or highly valued features as defined in *Tenacity*, and . The view sharing outcome is equitable, reasonable and

VIEW PLACE 14A - UNIT 1, LEVEL 2, 180-186 COOGEE BAY ROAD EXISTING VIEW





Figure 41 Existing view north-east from unit 1 balcony - level 2 - 180.Coogee Bay Road

This is a north-easterly view from a level two unit balcony, associated with kitchen and living areas. The balcony extends along the entire east and south elevation of the unit, offering expansive views to the north, north-east and east. The composition is predominantly characterised by a foreground and mid-ground of development including two to four storey buildings. The upper parts of the existing boutique hotel are visible to the south-east. The distant mid-ground and back ground include the Norfolk Island tree canopies along Goldstein Reserve promenade, which filter views a section of open undifferentiated water and sea-sky horizon beyond.



Figure 42 Proposed View including central view corridor which sits below the LEP height control and maintains access to a central section of sea-sky horizon.

There is no change to the foreground composition or spatial arrangement of built forms in close views. The lower complying parts of the proposed development will replace buildings roof forms where a short section of sea-sky horizon and beach side tree canopy to the north is retained via the view corridor. The additional height sought either side of the view corridor as shown in blue rises approximately to the height of the existing boutique hotel ridgeline and extends to the north beyond this existing roof form, to block a minor additional section of sea-sky horizon and open areas of sky. The non-complying upper parts of the proposed development do not block locally significant visual features. The composition to be lost is not considered as iconic, scenic or highly valued in isolation or a 'whole view' as described in *Tenacity*. The wider views available to the north-east, north, south and west from this dwelling remain unaffected by the proposed development.



ADDITIONAL VIEWS AVAILABLE FROM UNIT 1, LEVEL 2, 180-186 COOGEE BAY ROAD



Photo 47. View northeast from unit 1 balcony - level 2 -180 Coogee Bay Road





Photo 48. View east from unit 1 living room - level 2 -180 Coogee Bay Road

Photo 49. View sout Bay Road

Dwelling Address	Description	Photomontage number	<i>Tenacity</i> Step 1, Existing views to be affected?	<i>Tenacity</i> Step 2, From where are the views available?	<i>Tenacity</i> Step 3, Extent of view impacts for whole dwelling (consider room type and use and unaffected views)	Steps in <i>Tenacity</i> - where threshold test is met	Step 4 - summary statement, reasonableness in tl
Unit 1 180-186 Coogee Bay Road	Level 2 mid-level unit, directly below level 5 located at the east end of the residential flat building.	View Place 14A	Views affected include a partial view characterised by sea sky horizon and sky. These features are not considered as highly valued in <i>Tenacity</i> .	Views are obtained across the formal side boundary of this residential flat building, which presents to Coogee Bay Road. A similar view composition is available from some seated positions and more limited, constrained views in relation to open-plan living and kitchen areas.	Negligible-minor	1,2,3	The view impact rating is negligible-minor as a res- view loss, retention of other views from the dwelli interface which will remain unaffected by the pro- the built form proposed do not block views to high (as part of the Clause 4.6 variation application) pre- section of sea-sky horizon north of the section bloc height sought blocks a minor extent of view that is reduction in height to meet the LEP height control and would not significantly improve views or amer- acceptable.

Figure 43 *Tenacity* assessment table

View south from unit 1 balcony - level 2 -180 Coogee

the context of non-compliance.

result of the combination of the quantum and quality of elling including to Dolphins Point headland and land-water proposed development. The non-compliant upper parts of ighly-valued features where the additional height sought predominantly blocks areas of sky and a short additional blocked by the complying development. The additional t is not considered as highly valued in *Tenacity* terms. A rol would not reveal more scenic or highly valued features nenity. The view sharing outcome is reasonable and

VIEW PLACE 16 - 17 VICAR STREET EXISTING VIEW



Figure 44 Existing view east from 17 Vicar Street master bedroom's balcony - level 1

PROPOSED VIEW



Figure 45 Proposed view

Easterly views are available from both floors at this dwelling. The modelled view is from the main living area. The foreground is constrained by the south elevation brick wall of 15 Vicar Street which bounds the site, low vegetation and the west end of the 3 storey residential flat building at 230 Ardern Street. The gap between built forms reveals a narrow view corridor which includes beach side Norfolk Pines, a section of Coogee Beach and distant open water and sea sky horizon. The lower part of the view includes flat roof forms on the subject site.

The proposed development includes the demolition of 15 Vicar Street, which is replaced by significantly lower built form including the south arm of the proposed development. The proposed envelope extends to the east sitting well below the LEP height control so that all parts proposed development are fully complying. The complying parts of the proposed development will block the lower part of the view but the long section of sea-sky horizon is retained.



ADDITIONAL VIEWS AVAILABLE FROM 17 VICAR STREET



Photo 50. View northeast from 17 Vicar Street balcony - ground floor



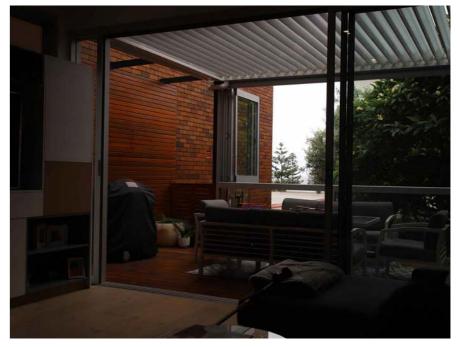


Photo 51. Standing view east from 17 Vicar Street living room - ground floor

Photo 52.

Dwelling Address	Description	Photomontage number	<i>Tenacity</i> Step 1, Existing views to be affected?	<i>Tenacity</i> Step 2, From where are the views available?	<i>Tenacity</i> Step 3, Extent of view impacts for whole dwelling (consider room type and use and unaffected views)	Steps in <i>Tenacity</i> - where threshold test is met	Step 4 - summary statement, reasonableness in th
17 Vicar Street, Coogee	Two storey dwelling, individual dwelling immediately adjacent to the subject site.	View Place 16	Views affected include a partial open water view	Views are available obliquely, across the side boundary from standing positions at both floors and some seated positions from the first floor.	Minor	1, 2, 3	All view loss is caused by built form that is fully co significantly below it. No parts of the additional hei visible. Notwithstanding, view loss will be experier across side boundaries are acknowledged as being open undifferentiated water will be lost, however t The partial view of open undifferentiated water is r characterised by scenic or highly valued feature su unique features such as Dolphin Point or Wedding blocked by lower complying parts of the proposed view impact rating overall, the view sharing outcor

Figure 46 Tenacity assessment table

Seated view northeast from 17 Vicar Street living room ground floor

the context of non-compliance.

r complying with the LEP height control and sits height sought as part of the Clause 4.6 variation are rienced from a living area and first floor bedroom. Views eing more difficult . The lower part of the partial view of er the long section of sea-sky horizon will be retained.

is not part of a whole view that is predominantly e such as land-water interface, icons or locally known ing Cake Island. All water views (scenic features) are sed development. On balance notwithstanding a moderate come is acceptable.

VIEW PLACE 15 - UNIT 9, LEVEL 3, 41-43 CARR STREET EXISTING VIEW



Figure 47 Existing view east from unit 9, level 3, living room's balcony - 41 Carr Street

This is a distant easterly view from the eastern balcony associated with the living area and across the side boundary of the development. The foreground includes a variety of vegetation which filters existing views to the open water. The mid-ground view is predominately characterised by residential dwellings and various roof forms. The background view includes open water in Coogee Bay, a wide section of sea-sky horizon and heavily filtered partial views to Dolphins Point. Similar but more constrained compositions are available from a living room window, and bedroom located along the east elevation of the unit.

PROPOSED VIEW



Figure 48 Proposed view

There will be no change to the foreground or spatial arrangement of the view. The complying parts of the proposed development will occupy a minor part of the mid-ground composition blocking existing built form. The south end of the non-complying central flat roof blocks a minor extent of water and lower part of a rock platform, south of the boutique hotel roof form. The majority of the section of land-water interface south of Dolphin Point and the extensive section of sea-sky horizon remain visible and unaffected by the proposed development.



ADDITIONAL VIEWS AVAILABLE FROM UNIT 9, LEVEL 3, 41-43 CARR STREET







Photo 58.

Carr Street

Photo 56. View east from unit 9 living room - level 3 - 41 Carr Street

View east from unit 9 dinning room - level 3 -41 Carr Photo 57. Street

Dwelling Address	Description	Photomontage number	<i>Tenacity</i> Step 1, Existing views to be affected?	<i>Tenacity</i> Step 2, From where are the views available?	<i>Tenacity</i> Step 3, Extent of view impacts for whole dwelling (consider room type and use and unaffected views)	Steps in <i>Tenacity</i> - where threshold test is met	Step 4 - summary statement, reasonableness in th
9/41-43 Carr Street Coogee	2nd level, 3rd storey north end unit within a residential flat building located along the elevated north side of Carr Street.	View Place 15	Built form, triangular sections of water south of the boutique hotel	Balcony associated with a living area and partial views from bedrooms and partial seated view from living room. All views are gained over a side boundary.	Negligible-minor in relation to complying built form and minor in relation to non-complying built form.	1,2,3	The majority of the proposed development includin by vegetation. In this regard the proposal blocks a characterised by scenic and highly valued items in significantly improve views or amenity. The view sh

Figure 49 *Tenacity* assessment table

Standing view east from unit6 bedroom - level 3 - 41

ding the additional height sought is heavily screened a minor extent of view that is not predominantly s in *Tenacity* terms . A reduction in height would not sharing outcome is reasonable and acceptable.

VIEW PLACE 17A - UNIT 5, 14 KIDMAN STREET EXISTING VIEW



Figure 50 Existing view northeast from unit 5 balcony - 14 Kidman Street

This is an oblique view is from the north eastern balcony. The foreground composition is characterised by vegetation, roof forms and residential dwellings and part of the Coogee Bay Boutique Hotel. The background view includes Dunngingham Reserve and open water in Coogee Bay, in addition to a Dolphin Point and associated land-water interface. Views from the balcony are available in a wide arc from west to east, such that the proposed development will occupy only a minor part of the much wider panoramic view.

The height and scale of the complying parts of the proposed development block existing built form and a minor extent of open water to the south as the LEP height plane increases along Vicar Street. The additional height sought as shown in blue will introduce a new contemporary flat-roof form into the mid-ground composition. The non-complying parts of the proposed development block built form, vegetation and a minor extent of open water to the north and south of the Boutique Hotel roof form. All of the scenic and highly valued parts of the view as defined in *Tenacity* are unaffected by the built form proposed.

PROPOSED VIEW

Figure 51 Proposed view





ADDITIONAL VIEWS AVAILABLE FROM UNIT 5, 14 KIDMAN STREET



Photo 59. View north from unit 5 balcony - 14 Kidman Street





Photo 60 . View north-west from unit 5 balcony - 14 Kidman Street

Photo 61.

Dwelling Address	Description	Photomontage number	<i>Tenacity</i> Step 1, Existing views to be affected?	<i>Tenacity</i> Step 2, From where are the views available?	<i>Tenacity</i> Step 3, Extent of view impacts for whole dwelling (consider room type and use and unaffected views)	Steps in <i>Tenacity</i> - where threshold test is met	Step 4 - summary statement, reasonableness in th
5/14 Kidman Street, Coogee	Three storey dwelling, north end unit, within an expansive residential flat building.	View Place 17A	Views affected include scenic features as defined In <i>Tenacity</i>	Standing and seated views over a formal (technical) property side boundary.	Negligible or less	1,2,3	The proposed development, including the additional does not create any significant view loss or view im control would not reveal more scenic or highly valu or amenity. The negligible view impact is reasonab supportable in our opinion.

Figure 52 *Tenacity* assessment table

View west from unit 5 balcony - 14 Kidman Street

the context of non-compliance.

ional height sought as part of the Clause 4.6 variation, v impacts. A reduction in height to meet the LEP height valued features and would not significantly improve views hable and the view sharing outcome is acceptable and

VIEW PLACE 17B - UNIT 3, 14 KIDMAN STREET EXISTING VIEW



Figure 53 Existing view east from unit 3 balcony - 14 Kidman Street



Figure 54 Proposed view

This view is from the north eastern balcony that has an expansive view from north to south. The foreground composition is characterised by vegetation, roof forms and residential dwellings and a portion of the Coogee Bay Boutique Hotel in the distance. The background view includes Dunngingham Reserve and open water in Coogee Bay, in addition to a highly scenic view to Dolphin Point. Views from the balcony are available in a wide arc from west to east, such that the proposed development will occupy only a minor part of the much wider panoramic view.

The height and scale of the complying parts of the proposed development block existing built form and minor extent of water in the north part of Coogee Bay. The additional height sought as shown in blue will introduce a new contemporary flat-roof form into the mid-ground composition. The non-complying parts of the proposed development including the highest central flat-roof section block existing built from, vegetation and a very minor extent of open water to the north and south of the Boutique Hotel's existing roof form. All of the scenic and highly valued parts of the view as defined in *Tenacity* are unaffected by the built form proposed.

ADDITIONAL VIEWS AVAILABLE FROM UNIT 3, 14 KIDMAN STREET



Photo 61. View northeast from unit 3 balcony - 14 Kidman Street



Photo 62. View north from unit 3 balcony - 14 Kidman Street



Photo 63. View north-west from unit 3 balcony - 14 Kidman Street

Dwelling Address	Description	Photomontage number	<i>Tenacity</i> Step 1, Existing views to be affected?	<i>Tenacity</i> Step 2, From where are the views available?	<i>Tenacity</i> Step 3, Extent of view impacts for whole dwelling (consider room type and use and unaffected views)	Steps in <i>Tenacity</i> - where threshold test is met	Step 4 - summary statement, reasonableness in th
3/14 Kidman Street, Coogee	Three storey dwelling, north end unit, within an expansive residential flat building.	View Place 17B	Views affected include scenic features as defined In <i>Tenacity</i>	Standing and seated views over a formal (technical) property side boundary.	Negligible or less	1,2,3	The proposed development, including the additiona does not create any significant view loss or view im control would not reveal more scenic or highly valu views or amenity. The negligible view impact is rea supportable in our opinion.

Figure 55 *Tenacity* assessment table

the context of non-compliance.

onal height sought as part of the Clause 4.6 variation, v impacts. A reduction in height to meet the LEP height valued features and would not significantly improve reasonable and view sharing outcome is acceptable and

VIEW PLACE 18 - UNIT 5, LEVEL 2, 119 BROOK STREET EXISTING VIEW



Figure 56 Existing close view northeast from unit 5 balcony - level 2 - 119 Brook Street


This view is from the north end of an external balcony of a unit that presents to the north. A similar view is available from the west end of the balcony. The foreground to the east, is characterised by dense vegetation and mid-ground to the north-east by pitched roof forms including neighbouring residential dwellings and the upper levels of the existing Coogee Bay Boutique Hotel. The distant background to the north-east includes the upper topography and vegetation in Dunningham Reserve, isolated residential flat buildings and two sections of sea-sky horizon either side of the Boutique Hotel pitched roof. The northern section reveals wave action in relation to rockshelfs and platform north of Dolphin Point. The scenic features available form a partial view, where the wider view available is not predominantly characterised by highly valued scenic features, icons or whole views as defined in *Tenacity*.

PROPOSED VIEW



Figure 57 Proposed view

The lower complying parts of the proposed development will replace views of the existing boutique hotel. The additional height sought as shown in blue rises to a similar height to the existing boutique hotel ridgeline but reduces in height as it extends to the north beyond this existing sloped roof. An additional section of distant rock face and wave action will be revealed as a result of the proposed envelope. The non-complying parts of the proposed development block a minor extent of a scenic composition including a section of seasky horizon but do not block views to rock outcrops or Dunningham Reserve. The updated DA retains the scenic parts of the view including Dolphin Point headland and distant rock outcrops. The expansive views available to the north-east, north, south and west from this dwelling remain unaffected by the proposed development. Notwithstanding the non-compliant form blocks a section of open water and sea-sky horizon, it does not block a whole view predominantly characterised by highly valued scenic features, icons as defined in *Tenacity*.

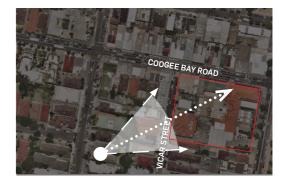

ADDITIONAL VIEWS AVAILABLE FROM UNIT 5, LEVEL 2, 119 BROOK STREET



Seated view east from unit 5 balcony - 119 Brook Street



Photo 65 . View northeast from unit 5 balcony - 119 Brook Street

Photo 66 .

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Dwelling Address	Description	Photomontage number	<i>Tenacity</i> Step 1, Existing views to be affected?	<i>Tenacity</i> Step 2, From where are the views available?	<i>Tenacity</i> Step 3, Extent of view impacts for whole dwelling (consider room type and use and unaffected views)	Steps in <i>Tenacity</i> - where threshold test is met	Step 4 - summary statement, reasonableness in t
5/119 Brook Street	2nd level centrally located unit along the north elevation of this three storey residential flat building.	View Place 18	Views affected include a partial view which includes valued and scenic features as defined In <i>Tenacity</i> .	Standing and seated oblique views from balcony and bedroom across a side boundary. We acknowledge that this is considered as a primary view from the dwelling by the resident.	Negligible in relation to non-complying and complying built form.	1,2,3	The view impact rating is minor when considering the room types to be affected and availability of ot access via the side boundary and compliance with new built form replaces existing built form and a s additional scenic parts of Dolphin Point via the view the Clause 4.6 variation application predominantly of sea-sky horizon. These features are not conside compared to highly scenic whole views. The view i context of the wider views available, which remain

Figure 58 *Tenacity* assessment table

Photo 64.

View northeast from unit 5 bedroom - 119 Brook Street

the context of non-compliance.

ng all relevant factors including the quantum of view loss, f other, unaffected views from the whole dwelling and rith controls. A minor part of the view will be lost where a short section of open water. The s.34 envelope reveals view corridor where the additional height sought as part of ntly blocks areas of undifferentiated water and a section idered to be scenic or highly valued in *Tenacity* terms w impact for the whole dwelling is acceptable in the iain unaffected.

VIEW PLACE 7 - PENTHOUSE BALCONY, 57-63 ST PAUL STREET EXISTING VIEW



Figure 59 Existing view east from unit 79 Penthouse balcony - 57-63 St Paul Street

This view is from the penthouse balcony at the Grove. The view is expansive from north to west, where the immediate foreground is occupied by rooftop and balcony areas. The northerly mid-ground composition includes a range of low-height and density residential development which springs from lower elevation relative to the view place, so that expansive views to the east and north are available including to parts of Randwick and Coogee. The background composition includes a wide arc of view and long section of uninterrupted sea-sky horizon.

The proposal is of low visibility in this view and others from this dwelling. The complying height envelope blocks a minor amount of open water and is of low visibility from this distance. The proposed development is visible in the distant background at the east end of Coogee Bay Road where it occupies a negligible amount of the view. The height and scale of the proposed development is not highly visible, does not dominate the view

not block a whole view characterised by scenic features.











or change the predominant visual character or scenic quality of the view. The Proposed development does

ADDITIONAL VIEW AVAILABLE FROM 57-63 ST PAUL STREET



Photo 67. Existing view northeast from unit 79 Penthouse balcony - 57-63 St Paul Street

Dwelling Address	Description	Photomontage number	<i>Tenacity</i> Step 1, Existing views to be affected?	<i>Tenacity</i> Step 2, From where are the views available?	<i>Tenacity</i> Step 3, Extent of view impacts for whole dwelling (consider room type and use and unaffected views)	Steps in <i>Tenacity</i> - where threshold test is met	Step 4 - summary statement, reasonableness in f
The Grove 57-63 St Paul Street, Randwick	Five storey aged care dwelling	View Place 7	Water feature	Balcony associated with living areas. Similar views are not available from inside the dwelling.	Negligible or less	1	The proposed development, including the additio application, creates minimal view loss and no sig sharing outcome is reasonable and acceptable.

Figure 61 Tenacity assessment table

the context of non-compliance.

tional height sought as part of the Clause 4.6 variation significant amenity impacts for this dwelling. The view

7.0 ADDITIONAL VIEWS REQUESTED BY COUNCIL

201 COOGEE BAY ROAD ROOFTOP

UNIT 3, LEVEL 3, 130 BROOK STREET

UNIT 16, LEVEL 3, 201 COOGEE BAY ROAD

UNIT 5, LEVEL 3, 134 BROOK STREET

UNIT 12A, LEVEL 3, 28 KIDMAN STREET

UNIT 15, LEVEL 3, 28 KIDMAN STREET

UNIT 22, LEVEL 6, 183 COOGEE BAY ROAD



AE Design have prepared the following images to show the updated DA.


The images have been prepared based on independent survey data for view place locations and the site including visible fixed features in each view, to be able to locate, insert, rotate and accurately align the 3D architectural model.

We note that the images do not differentiate the complying and noncomplying parts of the updated DA in views. In this regard, Urbis have made assumptions regarding the quantum and quality of the view loss in terms of compliance.

Our assumptions are based on our understanding of the proposed development, and a comparison of these views to Urbis views which are from similar locations and distances.

From the following view locations the visibility of the taller southern and northern forms is low where the upper most parts of each exceed the LEP control by a minor extent.

In this way the images are accurate and faithful in their assessment of potential view loss and over all view impacts for each whole dwelling.

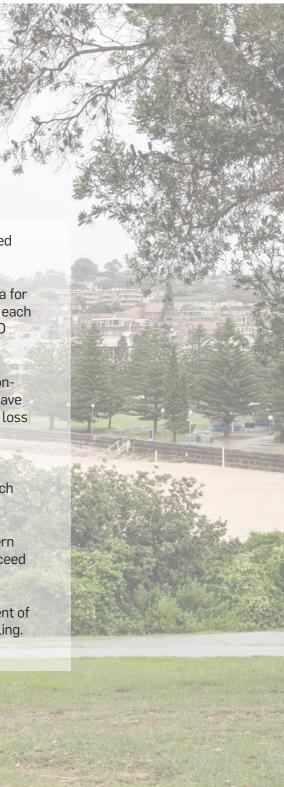

AE DESIGN PHOTOMONTAGE VIEW LOCATIONS



Figure 62 AE View Location Map

201 COOGEE BAY ROAD ROOFTOP EXISTING VIEW



Figure 63 Existing view looking east towards

Close direct views from the three individual roof top areas to the subject site are available. The foreground composition is predominantly characterised by two and three storey commercial buildings along Coogee Bay Road, including the existing heritage hotel and boutique hotel to the south-east. The mid-ground includes a vignette to Coogee Bay beach and the distinctive columnar Norfolk Island tree canopies and to the north-east the upper parts of Dunningham Reserve at Dolphins Point. The background view includes open undifferentiated water in Coogee Bay, and at low tide wave action associated with the rock platform Wedding Cake Island. This view is only available from the north-eastern most corner of the north roof, where views from the other roof tops do not include Wedding Cake Island

PROPOSED VIEW



Figure 64 Proposed view

The complying built form proposed blocks existing development. The additional height sought blocks vegetation, areas of open water where the wide spatial separation between non-complying taller parts of the s.34 envelope creates a view corridor. Inclusion of the view corridor allows for the retention of views from this shared roof top corner to the majority of Wedding Cake Island (when visible at low tide).



ADDITIONAL VIEWS AVAILABLE FROM 201 COOGEE BAY ROAD ROOFTOP



Photo 68. View east from east rooftop

Dwelling Address	Description	Photomontage number	<i>Tenacity</i> Step 1, Existing views to be affected?	<i>Tenacity</i> Step 2, From where are the views available?	<i>Tenacity</i> Step 3, Extent of view impacts for whole dwelling (consider room type and use and unaffected views)	Steps in <i>Tenacity</i> - where threshold test is met	Step 4 - summary statement, reasonableness
5/201 Coogee Bay Road, Coogee	Shared common trafficable roof space, north-east edge.	View requested by Council -overlay prepared by AED	Water views	Standing views from one location from the north-eastern most edge of a roof top over a rear property boundary	Negligible-minor	1,2,3	The impact is reasonable given the access to this periods of time and is not from a private dwelling. of views to Wedding Cake Island. In addition all oth roof decks will remain unaffected by the proposed front and land-water interface visible along the Co sharing outcome is reasonable and acceptable.

Figure 65 Tenacity assessment table

is view is limited, unlikely to be viewed for sustained og. The inclusion of the view corridor allows for retention other expansive views from the majority of all three sed development. Views to Dolphin Point and the beach Coogee Bay Road corridor will be unaffected. The view

UNIT 3, LEVEL 3, 130 BROOK STREET EXISTING VIEW



Figure 66 Existing view looking east from living room balcony

This is a north-easterly view from a level three unit balcony. The foreground composition predominately consists of residential development and vegetation along Brook Street. The mid-ground view includes pitched and flat roof forms including the upper part of the boutique hotel roof form. The background view is expansive and includes parts of Dolphin Point headland, land-water interfaces further north beyond Dunningham Reserve and open water beyond Coogee Bay. Other expansive views are available to the north, north-west and east which will be unaffected by the proposed development.

PROPOSED VIEW





Figure 67 Proposed view

The height and scale of the proposed development block existing built form. The additional height sought as shown in blue will introduce a new contemporary flat-roof form into the mid-ground composition. The uppermost parts of the proposed development project to the north and south beyond the existing pitched roof, blocking vegetation, a minor extent rock outcrop and short section of open water to the south of the Boutique Hotel roof form. All of the scenic and highly valued parts of the view as defined in *Tenacity* including rock outcrops above the built form proposed, are unaffected by the s.34 proposed envelope and remain visible.



ADDITIONAL VIEWS AVAILABLE FROM UNIT 3, LEVEL 3, 130 BROOK STREET



Photo 69. View north-east from living room terrace



Photo 70. View north from living room terrace

Dwelling Address	Description	Photomontage number	<i>Tenacity</i> Step 1, Existing views to be affected?	<i>Tenacity</i> Step 2, From where are the views available?	<i>Tenacity</i> Step 3, Extent of view impacts for whole dwelling (consider room type and use and unaffected views)	Steps in <i>Tenacity</i> - where threshold test is met	Step 4 - summary statement, reasonableness
3/130 Brook St Coogee	Third floor unit located in a mid- slope location approximate 200m west of the subject site.	View requested by Council -overlay prepared by AED	Land and water views	Standing views from an external balcony	Negligible	1,2,3	The view impact is negligible due to the limited ext hotel roof form. The limited extent of view loss occu of the wide arc of view available will remain unaffec views to be lost do not include highly-valued feature water interface, icons or locally known unique feat The proposed development, including the additiona application, creates minimal view loss and no signif in height to meet the LEP control would not reveal significantly reduce view or amenity impacts. The v

Figure 68 Tenacity assessment table

extent of view loss created either side of the Boutique accurs within a much wider view available. The majority ifected by the non-complying built from proposed where tures such as whole views formed by water and landeatures such as Dolphins Point or Wedding Cake Island. onal height sought as part of the Clause 4.6 variation gnificant amenity impacts for this dwelling. A reduction hal more scenic or highly valued features and would not e view sharing outcome is reasonable and acceptable.

UNIT 16, LEVEL 3, 201 COOGEE BAY ROAD EXISTING VIEW



Figure 69 Existing view looking east from kitchen

This view is from the kitchen of the dwelling at level three. The foreground is predominantly characterised by vegetation, neighbouring dwellings and pitched roofs. The mid-ground view includes residential dwellings and the existing Coogee Bay Boutique Hotel. The background includes a minor part of Dunningham Reserve, vegetation located at Coogee Beach and the ocean to sky horizon.

PROPOSED VIEW



Figure 70 Proposed view

The height and scale of the proposed development block existing built form. The additional height sought as shown in blue will introduce two widely spaced, separate sections of contemporary flat-roof form into the mid-ground composition. The upper parts of the proposed development block vegetation, open water between tree canopy and areas of open sky. The upper built form largely blocks or replaces existing built from and does not block features or compositions that are defined as scenic or highly valued in *Tenacity* terms.



ADDITIONAL VIEWS AVAILABLE FROM UNIT 16, LEVEL 3, 201 COOGEE BAY ROAD



Photo 71. View east from bedroom window

Dwelling Address	Description	Photomontage number	<i>Tenacity</i> Step 1, Existing views to be affected?	<i>Tenacity</i> Step 2, From where are the views available?	<i>Tenacity</i> Step 3, Extent of view impacts for whole dwelling (consider room type and use and unaffected views)	Steps in <i>Tenacity</i> - where threshold test is met	Step 4 - summary statement, reasonableness
16/201 Coogee Bay Road	Upper floor south- end unit living room	View requested by Council -overlay prepared by Fenders Katsalidis	Partial open water view	Standing views only from the kitchen only in this dwelling	Negligible or less	N/A	The view impact is negligible or less for the whole additional height sought as part of the Clause 4.6 creates minimal view loss and no significant amer meet the LEP control would not reveal more scer is reasonable and acceptable.

Figure 71 Tenacity assessment table

ole dwelling . The proposed development, including the 6.6 does not block scenic and highly valued compositions, nenity impacts for this dwelling. A reduction in height to cenic or highly valued features. The view sharing outcome

UNIT 5, LEVEL 3, 134 BROOK STREET EXISTING VIEW



Figure 72 Existing view looking east from balcony

This view is from the third floor balcony associated with the living area. The view is expansive including a wide arc from north to south with a foreground composition predominately characterised by residential dwellings at Brook Street. The mid-ground is characterised by roofs and vegetation, where the distant background consists of Dunningham Reserve, land water interface and open water.

PROPOSED VIEW



Figure 73 Proposed view

The lower and upper parts of the proposed development are not visible in this view. Access to the subject site is blocked by intervening development. There are no visual effects or view loss caused by the proposed development



ADDITIONAL VIEWS AVAILABLE FROM UNIT 5, LEVEL 3, 134 BROOK STREET





Photo 72. View east from balcony

Photo 73 . View east from living room

Dwelling Address	Description	Photomontage number	<i>Tenacity</i> Step 1, Existing views to be affected?	<i>Tenacity</i> Step 2, From where are the views available?	<i>Tenacity</i> Step 3, Extent of view impacts for whole dwelling (consider room type and use and unaffected views)	Steps in <i>Tenacity</i> - where threshold test is met	Step 4 - summary statement, reasonableness
5/134 Brook Street, Coogee	Three storey dwelling, east end unit occupying the full length of the upper floor.	View requested by Council -overlay prepared by AED	N/A	N/A	Nil no view loss	N/A	N/A

Figure 74 Tenacity assessment table





UNIT 12A, LEVEL 3, 28 KIDMAN STREET EXISTING VIEW



Figure 75 Existing view looking north-east from living room

Views towards the site are available to the east from two rooms via the eastern side boundary. The views from the living room and kitchen are similarly characterised by a foreground of residential development and roofs, mid-ground development including parts of the subject site which are screened by dense vegetation. The distant background includes parts of Dunningham Reserve, a wide section of open water and sea-sky horizon and taller built form to the south.

PROPOSED VIEW



Figure 76 Proposed view

A minor extent of the envelope is visible in the distant background, ans is of low visibility where no substantive view loss in either qualitative or quantitative will occur.



ADDITIONAL VIEWS AVAILABLE FROM UNIT 12A, LEVEL 3, 28 KIDMAN STREET





Photo 74 View east from living room

Photo 75. View east from kitchen

Dwelling Address	Description	Photomontage number	<i>Tenacity</i> Step 1, Existing views to be affected?	<i>Tenacity</i> Step 2, From where are the views available?	<i>Tenacity</i> Step 3, Extent of view impacts for whole dwelling (consider room type and use and unaffected views)	Steps in <i>Tenacity</i> - where threshold test is met	Step 4 - summary statement, reasonableness
12a/28 Kidman St Coogee	Three storey residential flat building dwelling in a mid slope location approximately 200m west of the subject site	View requested by Council -overlay prepared by AED	Open water view	Standing views from kitchen and living area	Negligible or less	N/A	The view impact is negligible or less for the whole additional height sought as part of the Clause 4.6 c creates minimal view loss and no significant amen meet the LEP control would not reveal more scen is reasonable and acceptable.

Figure 77 Tenacity assessment table

ble dwelling . The proposed development, including the .6 does not block scenic and highly valued compositions, menity impacts for this dwelling. A reduction in height to cenic or highly valued features. The view sharing outcome



UNIT 15, LEVEL 3, 28 KIDMAN STREET EXISTING VIEW



Figure 78 Existing view looking north-east from living room

Views towards the site are available to the east from two rooms via the eastern side boundary. The views from the living room and kitchen are similarly characterised by a foreground of residential development and roofs, mid-ground development including parts of the subject site the majority of which is heavily screened by dense vegetation. The distant background includes parts of Dunningham Reserve, a section of open water and sea-sky horizon and taller built form to the south.

PROPOSED VIEW



Figure 79 Proposed view

A limited extent of the proposed built form is visible in the distant background, where no substantive view loss in either qualitative or quantitative will occur.



ADDITIONAL VIEWS AVAILABLE FROM UNIT 15, LEVEL 3, 28 KIDMAN STREET



Photo 76. Close view north-east from kitchen

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Dwelling Addres	5 Description	Photomontage number	<i>Tenacity</i> Step 1, Existing views to be affected?	<i>Tenacity</i> Step 2, From where are the views available?	<i>Tenacity</i> Step 3, Extent of view impacts for whole dwelling (consider room type and use and unaffected views)	Steps in <i>Tenacity</i> - where threshold test is met	Step 4 - summary statement, reasonableness
Unit 15 28 Kidmar Street	Three storey residential flat building dwelling in a mid slope location approximately 200m west of the subject site	View requested by Council -overlay prepared by Fenders Katsalidis	Open water view	Standing views from living room	Negligible or less	N/A	The view impact is negligible or less for the whole additional height sought as part of the Clause 4.6 creates minimal view loss and no significant amer meet the LEP control would not reveal more scer is reasonable and acceptable.

Figure 80 Tenacity assessment table

ole dwelling . The proposed development, including the 6.6 does not block scenic and highly valued compositions, nenity impacts for this dwelling. A reduction in height to cenic or highly valued features. The view sharing outcome

UNIT 22, LEVEL 6, 183 COOGEE BAY ROAD EXISTING VIEW



Figure 81 Existing view looking east from balcony

This view is from the level seven balcony, associated with living areas providing an expansive view from north to east. Notwithstanding the view is potentially expansive, tall box hedging included in foreground planter boxes, blocks the majority of standing views to the east.

PROPOSED VIEW





Figure 82 Proposed view

The proposed development introduces a narrow horizontal section of built form into the view. The lower parts of the massing proposed are not visible. The additional height sought as shown in blue rises approximately to a height defined by the existing boutique hotel ridgeline and extends to the north and south beyond this existing form, blocking a minor extent of open and undifferentiated water and the upper canopy of some beach-side vegetation. These features are not considered as scenic or highly valued in *Tenacity* terms. The upper parts of the proposed development do not block locally significant visual features such as Wedding Cake Island or Dolphin Point. The upper parts of the proposed development do not dominate the view, significantly alter the scenic quality of the whole view and create a minor or less extent of view loss.

ADDITIONAL VIEWS AVAILABLE FROM UNIT 22, LEVEL 6, 183 COOGEE BAY ROAD





Photo 77. View north from balcony

Photo 78 View north

iew i	north	east	from	ba	lcony.
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Dwelling Address	Description	Photomontage number	<i>Tenacity</i> Step 1, Existing views to be affected?	<i>Tenacity</i> Step 2, From where are the views available?	<i>Tenacity</i> Step 3, Extent of view impacts for whole dwelling (consider room type and use and unaffected views)	Steps in <i>Tenacity</i> - where threshold test is met	Step 4 - summary statement, reasonableness in th
22/183 Coogee Bay Road	Penthouse Level east facing unit	View requested by Council -overlay prepared by Fenders Katsalidis	A short, narrow horizontal section of existing built form, open water and vegetation	Standing views only from an external balcony, via a side property boundary	Negligible or less	1,2,3	The proposed development, including the additiona application, creates minimal view loss and no signi sharing outcome is reasonable and acceptable.

Figure 83 Tenacity assessment table

the context of non-compliance.

onal height sought as part of the Clause 4.6 variation gnificant amenity impacts for this dwelling. The view

8.0 RELEVANT PLANNING PRINCIPLES

8.1 TENACITY

View loss is a term which refers to the extent to which a new built form will block an existing view or part of the composition of a view that is currently enjoyed by others. Where a proposed development is likely to adversely affect views from private property, view sharing outcomes are routinely assessed against the Planning Principle established in the Land and Environment Court; *Tenacity* Consulting v Warringah Council [2004] NSWLEC 140 (*Tenacity*).

Tenacity is the most widely used and referenced planning principle in relation to the assessment of impacts on private views and view sharing.

The planning principle is described by the Court as a statement of a 'desirable outcome' aimed at reaching a planning decision and defines a number of appropriate matters to be considered in making that decision. Therefore, the importance of the principle is in outlining all relevant matters and or the relationships of those factors to be considered and is not simply a process of listing features in a composition that may be lost and is not limited to an assessment of view loss as shown in a particular view.

In other words, *Tenacity* is a 'recipe' designed to guide decision-making where the end goal is to reach an equitable and reasonable view-sharing outcome.

Prior to undertaking Step 1 of the assessment, Roseth discusses in paragraph 25 the notion of view sharing as quoted below.

"The notion of view sharing is invoked when a property enjoys existing views, and a proposed development would share that view by taking some of it away for its own enjoyment. (Taking it, all away cannot be called view sharing, although it may, in some circumstances, be quite reasonable.) To decide whether or not view sharing is reasonable, I have adopted a four-step assessment."

The planning principle states that consideration should be given to the causes of the visual impact and whether they are reasonable in the circumstances. As stated in the preamble to the four-step process in *Tenacity*, a development that takes the view away from another may notwithstanding be considered reasonable. This is important because it also means that a severe or devastating level of impact can nevertheless be reasonable.

Tenacity includes a four-step threshold test, which we understand the steps are sequential and conditional, so that proceeding to further steps may not be required if the conditions for satisfying the preceding threshold test are not met. In other words, view loss may meet the threshold test for Step 1 or 2 but if the view loss is negligible in quantitative or qualitative terms there may be no utility or purpose served in continuing the assessment and in this regard, *Tenacity* has no work to do. We are aware that in the context of a Clause 4.6 variation, that view or amenity impacts are a determinative criteria and as such all Steps in *Tenacity* should be applied no matter the extent or nature of the view loss.

Tenacity does not clearly distinguish between extent (quantity) of view loss and in fact dissuades the use of quantifying view loss, but tends to equate view loss with impact, where the significance or importance of the loss is a matter of judgement and consideration of various relevant factors.

8.2 TENACITY RATINGS

In arriving at an over all view impact rating it is important to consider all relevant factors in Steps 1, 2 and 3 for the whole dwelling, not just potential view loss as shown in one selected photomontage. In general across the dwellings inspected only views in one direction to the east are affected, where the majority of dwellings enjoy expansive views to the north, north-east, south-east and south.

We have described whole views and partial views, where a 'whole view' is based on the intent described by Senior Counsel Roseth in *Tenacity* as follows;

The *Tenacity* Planning Principle includes a description of what makes a whole view, as being based on the combination of the main scenic features present in the view. This combination of the predominant features in the foreground, mid-ground and background form a whole view.

Further Roseth states that water on its own is of less value compared to compositions where water is combined with land-water interface. For example the loss of a part of Dolphin Point or Wedding Cake island where water and landforms are combined would be considered of greater value than a section of open undifferentiated water in isolation.

Roseth does not refer to a whole view being simply a whole view of a particular, individual feature or even an icon, noting that the presence of part or all of an icon is still relevant.

The views of Coogee Bay including the locally known topographical features of Dolphin Point (rock platforms, cliff and land-water interfaces and Wedding Cake Island visible at low tide) are not in our

4.0 TENACITY ASSESSMENT SUMMARY

opinion, considered to be 'lconic' in the sense that they are regionally or internationally recognisable as unique or iconic items. In other words views to Coogee Bay which include those features are not iconic, but rather are highly valued in a holistic sense as part of the wider scenic quality of the view.

It is illogical for a view of low relative scenic quality based on the main characteristics present including existing building development in the foreground and mid-ground (as is the case for many of the views modelled) that an inconsequential extent of view loss could lead to anything other than minor or negligible view impact ratings.

Further to applying the *Tenacity* rating scale, I refer to Roseth's own use of the rating scale in that matter, regarding the loss of a what he describes as a 'magnificent view' available from 7 Bellevue Place. We note that Roseth also clearly defines the 'whole' view this instance as being "the view to the ocean and Manly"

Paragraph 30 of the planning principle is quoted below;

I would classify the view to the ocean and Manly as highly valuable, what most people would describe as magnificent. It is now available from four levels from the rear. The proposal would obliterate views from the lower three levels from sitting and standing positions. From the fourth level it would obliterate it from sitting positions and reduce it from standing positions. In my opinion, the impact would be severe.

In this matter, Roseth rates a significant extent of view loss from 3.5 floors and multiple rooms within a dwelling, that is available across a rear boundary from seated and standing positions. Notwithstanding this significant loss of a 'magnificent view' to a whole view characterised by scenic and highly valued features, from all four levels of the dwelling, the view impact is only severe.

Urbis have used this guidance to inform our view impact ratings for each dwelling.

Prepared by Urbis for SIMMATTOWN PTY LTD 73

TENACITY ASSESSMENT TABLE - ALL VIEWS MODELLED

Dwelling Address	<i>Overall view impact for whole of dwelling</i> <i>Tenacity</i> Step 3, Extent of view impacts for whole dwelling (consider room type and use and unaffecte
1/113 Brook Street	Minor
19/183 Coogee Bay Road	Negligible-minor
19/183 Coogee Bay Road	Negligible-minor
Unit 5 180-186 Coogee Bay Road, Coogee	Minor in relation to non-complying built from proposed. Negligible in relation to complying built
	Negligible-Minor
Unit 1 180-186 Coogee Bay Road	Negligible-minor
17 Vicar Street, Coogee	Minor
9/41-43 Carr Street Coogee	Negligible-minor
5/14 Kidman Street, Coogee	Negligible or less
3/14 Kidman Street, Coogee	Negligible or less
5/119 Brook Street	Minor in relation to non-complying and minor complying built form.
The Grove 57-63 St Paul Street, Randwick	Negligible or less

affected views)	
ng built form.	

ADDITIONAL VIEWS REQUESTED BY COUNCIL

	Dwelling Address	<i>Tenacity</i> Step 3, Extent of view impacts for whole dwelling (consider room type and
5/201 Coogee Bay Road, Coogee		Negligible-minor
3/130 Brook St Coogee		Negligible or less
16/201 Coogee Bay Road		Negligible or less
5/134 Brook Street, Coogee		N/A
12a/28 Kidman St Coogee		N/A
Unit 15 28 Kidman Street		Negligible or less
22/183 Coogee Bay Road		Negligible or less
	VIEWS INSPECTED BU	JT NOT MODELLED
2/57 St Paul's Street, Randwick		N/A
Unit 4 11 Kidman Street		N/A
18/201 Coogee Bay Road, Coogee		N/A
18/201 Coogee Bay Road, Coogee		N/A
2 Vicar Street		N/A
6/14 Kidman Street, Coogee		N/A
Unit 8 23-25 Vicar Street Unit 8		N/A
Unit 29 23-25 Vicar Street		N/A
		1

pe and use and unaffected views)

PRIVATE VIEWS INSPECTED

UNIT4 - 11 KIDMAN STREET



Photo 1. View east from unit 4 balcony - level 2 - 11 Kidman Street

UNIT 5-11 KIDMAN STREET



Photo 2. View northeast from unit 5 balcony - level 3 - 11 Kidman Street

UNIT 16/201 COOGEE BAY ROAD



Photo 3. View east from unit 16 kitchen's window - level 3 - 201 Coogee Bay Road



Photo 4. View east from unit 16 east bedroom's window - level 3 - 201 Coogee Bay Road

UNIT 12A - 28 KIDMAN STREET



View east from unit 12A level 3, living room Photo 79.



View east from unit 12A, 28 Kidman Street Photo 80.



Photo 81

UNIT 15 - 28 KIDMAN STREET



Photo 82`. View east from unit 15 living room - level 3 - 28 Kidman Street.



View northeast from unit 15 living room - level 3 - 28 Kidman Street



Photo 84.

View east from the kitchen 12A level 3 - 28 Kidman Street

Close view northeast from unit 15 kitchen - level 3 - 28 Kidman Street

UNIT 18 - 201 COOGEE BAY ROAD



Photo 85. Close view east from unit 18 living room's window - level 3 -201 Coogee Bay Road



View east from unit 18 living room's window - level 3 - 201 Photo 86 . Coogee Bay Road



Photo 87 .

UNIT 3/130 BROOK STREET



Photo 88. View east from unit 3 living room terrace, level 3, 130 Brook Street



Photo 89. View northeast from unit 3 living room terrace - level 3 - 130 Brook Street



Photo 90.

View north from unit 3 living room terrace - level 3 - 130 Brook Street

View east from unit 18 kitchen's window - level 3 - 201 Coogee Bay Road

UNIT 5/134 BROOK STREET



Photo 91. View east from unit 5 balcony, level 3, 134 Brook Street



Photo 92. View east from unit 5 balcony - level 3 - 134 Brook Street



Photo 93.

2 VICAR STREET



Photo 94. View east from 2 Vicar Street kitchen balcony - level 2



Close view east from 2 Vicar Street bedroom balcony - level 3 Photo 95.



Photo 96

level 3

View east from unit 5 living room- level 3 - 134 Brook Street

View east from 2 Vicar Street living room balcony -

201 COOGEE BAY ROAD EAST ROOFTOP



Photo 97 . View east from 201 Coogee Bay Road east building roof top

UNIT 6/14 KIDMAN STREET



Photo 98 . View east from unit 6 bedroom window at 14 Kidman Street

UNIT 5/119 BROOK STREET



Photo 99.

UNIT 8/23-25 VICAR STREET



Photo 100. View north-west from unit 8 balcony at 23-25 Vicar Street

80 Coogee Bay Hotel | View Analysis Report

View northeast from living room balcony at 119 Brook Streetlevel 2

UNIT 22/183 COOGEE BAY ROAD



View north from balcony at 183 Coogee Bay Road-level 6 Photo 101.



Photo 102. View northeast from balcony at 183 Coogee Bay Road- level 6



View east from balcony at 183 Coogee Bay Road-level 6

9.0 SUMMARY & CONCLUSION

The scheme analysed in this Revised View Sharing report is based on an 'agreed-in-principle' maximum building envelope (the s34 proposed envelope). This envelope has been prepared as part of ongoing without prejudice s34 conference discussions in relation to LECNSW Class 1 appeal case number 2021/00322119, between the applicant and respondent's urban design experts AE Design and GMU respectively.

The proposed envelope modelled by Urbis in photomontages and in overlays prepared by AE Design, shows the visual effects of the proposed development in selected views from 18 dwellings.

The proposed massing has been reduced in height and scale to minimise view loss and improve amenity for dwellings in Coogee Bay. In particular the proposed envelope includes a view corridor where built form sits below the LEP height control and provides for the retention of views to Wedding Cake Island and Dolphin Point in south-easterly and north-easterly views respectively.

Inclusion of the view corridor will benefit the closest and potentially most affected residents whom currently enjoy views to those local, scenic and highly valued.

The updated photomontages show the visual effects of a permissible height form according to the LEP height control of 12m. The complying development is shown in a red colour wash and the upper parts which exceed the height control are shown in a blue colour wash.

The two separate and taller parts of built form included in the proposed envelope which exceed the control are massed to allow for the view corridor and lower section between, as a means to promote a positive and reasonable view sharing outcome for local residents.

The significance of the view loss caused by each component has been assessed in the context of the Tenacity Planning Principle.

The s34 proposed envelope overall is reduced in horizontal extent in views from the west where the spatial separation created by the view corridor creates visual permeability through and across the site in relation to mid-slope easterly views.

The inclusion of the wide view corridor, visually reduces the scale along the length of Vicar Street and will create view sharing benefits to all elevated residential locations immediately west, south-west and northwest of the subject site including for example views from residential flat buildings in Brook Street (including those not inspected), Carr Street and units within the Adina Apartments.

Views from all 18 dwellings from the original sample of 27 dwellings inspected, have been modelled in either certifiable photomontages prepared by Urbis or accurate architectural overlays prepared by AE Design as requested by Council and the Court.

The views are described in terms of the predominant features present where the selected modelled view represents the 'worse case' view focussed on the site, noting that each dwelling has access to other views that do not include the subject site and will not be affected.

each whole dwelling.

All descriptions and ratings are tabulated in the *Tenacity* Summary Table above where Urbis found that there would be NIL impacts for 1 dwelling, negligible or less view impacts for 8 dwellings, negligibleminor view impacts for 6 dwellings, minor view impacts for 2 dwellings and a moderate view impact for one dwelling at 17 Vicar Street.

The view impact rating has been carefully considered using SC Roseth's own guidelines as to what constitutes a severe or greater impact. A severe impact is generated when all scenic and highly valued features that form a whole views, from all parts and of a dwelling, are likely to be lost.

This is not the case for any of the dwellings inspected, where the majority of views from each dwelling are largely unaffected, view loss is minor or less, and the scenic quality of the views are not predominantly characterised by highly valued features as defined in Tenacity.

Three dwellings most affected by potential view loss include 5/119 and 1/113 Brook Street and 17 Vicar Street, which are all rated as minor. The minor view impact rating is reasonable and acceptable for Brook Street dwellings given that the non-complying parts of the proposed envelope do not block scenic and highly valued features as defined in Tenacity.

The minor view impact for 17 Vicar Street is reasonable and acceptable given that it is entirely caused by built form which sits significantly below the height control therefore is fully compliant with controls that are relevant to view loss. Views to be lost are not considered as scenic or highly valued in Tenacity terms.

In summary out of 27 dwelling inspections, where potential view loss was modelled for 18 dwellings and rated as minor or less in all cases except for one dwelling.

Considering the likely view impacts across the subject site's immediate and wider potential visual catchment, based on the 18 representative views analysed and the low view impact ratings, in our opinion the view sharing outcome is reasonable and acceptable.

Visual impacts in all public domain views modelled is low and acceptable.

18 views have been modelled and assessed against the *Tenacity* Planning Principle to guide our assessment of overall view impacts for

10.0 APPENDICES

APPENDIX 1 PREPARATION OF URBIS PHOTOMONTAGES

Verification of accuracy- Key Steps

The fundamental requirement to be able to certify photomontages is that there is a 3D architectural model of the proposed development which can accurately located within the composition of a photograph.

In order to be able to certify the accuracy of the photomontage resulting from merging the 3D model and photographs is being able to demonstrate that the 3D model of the proposed building has a good fit to known surveyed markers on the existing building and other fixed features of the site or locality which are shown on the survey plan.

In addition the model must fit realistically into a photographic representation of the site in its context. Fender Katsalidis Architects prepared the 3D model of the proposed development using 3DSMax 2022 with Arnold 5.0 (3D Modelling and Render Engine), AutoCAD 2021, Globalmapper 23 (GIS Data Mapping / Processing) and Photoshop CC 2022 software and provided the model to Urbis, for insertion into base photographs.

Photographs

Each modelled view was captured by a professional photographer who attended each dwelling and was directed by Urbis Staff. Modelled views were captured with a Canon EOS 1D Mark 2 full frame camera, using 24mm, 35mm and 50mm focal lengths. This camera was mounted on a tripod at approximately 1.6m

The images are of sufficiently high resolution and taken with a variable lens of low distortion. The focal length of the lens used is appropriate for the purpose and has been standardised and stated to assist the photomontage artist. All photomontages are based on a the standardised 35mm focal length lens (FL) using single frame images. Single frame photographs are recommended for modelling as they have one centre of perspective and therefore included limited peripheral distortion at the outer edges of the image. Single frame photographic images are also recommended as the perspective in the 3D model of the proposed development that is generated by the computer, is most closely aligned to the perspective that occurs in a single frame photograph.

The reasons for using a specific focal length is determined by the vertical and horizontal scale of the subject of the view as well as the need to minimise apparent distortion of the images. The subject of the views commonly contains elements of vastly different horizontal and vertical scale, all of which must ideally be visible in each photograph. Given that the most instructive views of the proposed development are from close locations it was not practical to use a 50mm lens due to the horizontal extent of the proposed works could not fit into a single image.

Certification of accuracy

Urbis have reviewed the photomontages and is satisfied that the above requirements were met. In this regard Urbis can certify, based on the methods used and taking all relevant information into account, that the photomontages comply with the requirements for the preparation of photomontages as set out in the practice direction for the use of visual aids in the Land and Environment Court of New South Wales.

COOGEE BAY HOTEL, COOGEE, NSW

VIEW ANALYSIS - PHOTO-SIMULATIONS

PREPARED FOR SIMMATTOWN PTY LTD MARCH 2023



PHOTO-SIMULATIONS PREPARED BY:

Urbis. Level 10, 477 Collins Street, MELBOURNE 3000

DATE PREPARED :

1 March 2023

VISUALISATION ARTIST:

Ashley Poon, Urbis - Lead Visual Technologies Consultant Bachelor of Planning and Design (Architecture) with over 20 years' experience in 3D visualisation

LOCATION PHOTOGRAPHER:

Grant Leslie - PerfectImages Photography under direction from Jane Maze-Riley, Urbis - Associate Director, National Design

CAMERA:

Canon EOS 1D X Mark II - 20 Megapixel digital SLR camera (Full-frame sensor)

CAMERA LENS AND TYPE :

Canon EF 24-70mm f/2.8L II USM

SOFTWARE USED :

- 3DSMax 2022 with Arnold 5.0 (3D Modelling and Render Engine)
- AutoCAD 2021 (2D CAD Editing)
- Globalmapper 23 (GIS Data Mapping / Processing)
- Photoshop CC 2022 (Photo Editing)

DATA SOURCES :

- Point cloud and Digital Elevation Models from NSW Government Spatial Services datasets Sydney 2020-05
- Aerial photography from Nearmap 2021-12-21
- Site feature survey received via client survey dated 2020-02-28
- Proposed 3D model received from Architect 2023-02-06
- 12m height overlay 3D model received from Architect 2022-05-23
- Surveyed locations of photo viewpoint locations 2022-01-19 to 2022-01-20

METHODOLOGY:

Photo-simulations provided on the following pages have been produced with a high degree of accuracy to comply with the requirements as set out in the practice direction for the use of visual aids in the Land and Environment Court of New South Wales.

The process for producing these photo-simulations are outlined below:

- Photographs have been taken on site using a full-frame digital camera coupled with a guality lens in order to obtain high resolution photos whilst minimising image distortion. Photos are taken with the camera mounted to a tripod, at a standing height of 1.55m above natural ground level or above floor level. A surveyor has also been engaged to record the locations of the camera setup at each viewpoint location. Photos have been taken at a standard focal length of 50mm. A photo taken using the 50mm focal length on a full-frame camera (equivalent to 40° horizontal field-of-view / 46.8° diagonal field-of-view) is an accepted photographic standard to approximate human vision.
- Using available geo-spatial data for the site, including independent site surveys, aerial photography, digital elevation models and LiDAR point-clouds, the relevant datasets are validated and combined to form a georeferenced base 3D model from which additional information, such as proposed architecture, landscape and photographic viewpoints can be inserted.
- Layers of the proposed development are obtained from the designers as digital 3D models and 2D plans. All drawings/models are verified and registered to their correct geo-location before being inserted into the base 3D model.
- For each photo being used for the photo-simulation, the photo's survey location, camera, lens, focal length, • time/date and exposure information is extracted, checked and replicated within the 3D base model as a 3D camera. A camera match is created by aligning the 3D camera with the 3D base model against the original photo, matching the original photographic location and orientation.
- From each viewpoint, a reference 3D model camera match is generated to verify an accurate match between the base 3D model (existing ground survey/vegetation etc) and original photo. A 3D wireframe image of the 3D base model is rendered in the 3D modelling software and composited over the original photo using the photoediting software.
- From each viewpoint, the final photo-simulation is then produced by compositing 3D rendered images of the proposed development into the original photo with editing performed to sit the render at the correct view depth. Photographic elements are cross-checked against the 3D model to ensure elements such as foreground trees and buildings that may occlude views to the proposed development are retained. Conversely, where trees/ buildings may be removed as part of the proposal, these are also removed in the photo-simulation.



URBIS


COOGEE BAY HOTEL, COOGEE NSW - VIEW SHARING ASSESSMENT PHOTO-SIMULATIONS - VIEW LOCATION MAP



VP1 DOLPHINS POINT (PHOTO_1114989)

VP2 DOLPHINS POINT ROCK PLATFORM (PHOTO_1114998)



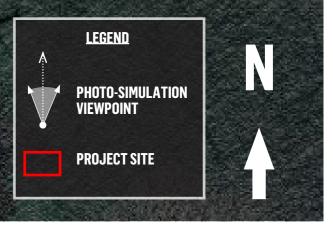

DATE: 2023-03-01 JOB NO: P0037817 DWG NO: VP_MAP REV: -



COOGEE BAY HOTEL, COOGEE NSW - VIEW SHARING ASSESSMENT VP1 : (PHOTO 1114989) LOOKING WSW, DOLPHINS POINT | EXISTING PHOTO : 2022-01-19 9:33 AEDT




ORIGINAL PHOTO EXTENT - 35MM VIEW

DATE: 2023-03-01 JOB NO: P0037817 DWG NO: VP_1A REV: -



COOGEE BAY HOTEL, COOGEE NSW - VIEW SHARING ASSESSMENT VP1 : (PHOTO 1114989) LOOKING WSW, DOLPHINS POINT | CAMERA MATCH 3D MODEL TO PHOTO

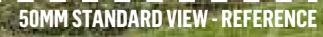



8a).

ORIGINAL PHOTO EXTENT - 35MM VIEW

DATE: 2023-03-01 JOB NO: P0037817 DWG NO: VP_1B REV: -



COOGEE BAY HOTEL, COOGEE NSW - VIEW SHARING ASSESSMENT VP1 : (PHOTO 1114989) LOOKING WSW, DOLPHINS POINT | PHOTO-SIMULATION

DISTANCE TO PROJECT - 380M ORIGINAL PHOTO EXTENT - 35MM VIEW

DATE: 2023-03-01 JOB NO: P0037817 DWG NO: VP_1C REV: -



COOGEE BAY HOTEL, COOGEE NSW - VIEW SHARING ASSESSMENT VP2 : (PHOTO 11I4998) LOOKING WSW, DOLPHINS POINT ROCK PLATFORM | EXISTING PHOTO : 2022-01-19 9:47 AEDT



ORIGINAL PHOTO EXTENT - 50MM STANDARD VIEW

DATE: 2023-03-01 JOB NO: P0037817 DWG NO: VP_2A REV: -




URBIS

COOGEE BAY HOTEL, COOGEE NSW - VIEW SHARING ASSESSMENT VP2 : (PHOTO 1114998) LOOKING WSW, DOLPHINS POINT ROCK PLATFORM | CAMERA MATCH 3D MODEL TO PHOTO

DATE: 2023-03-01 JOB NO: P0037817 DWG NO: VP_2B REV: -



COOGEE BAY HOTEL, COOGEE NSW - VIEW SHARING ASSESSMENT VP2 : (PHOTO 11I4998) LOOKING WSW, DOLPHINS POINT ROCK PLATFORM | PHOTO-SIMULATION

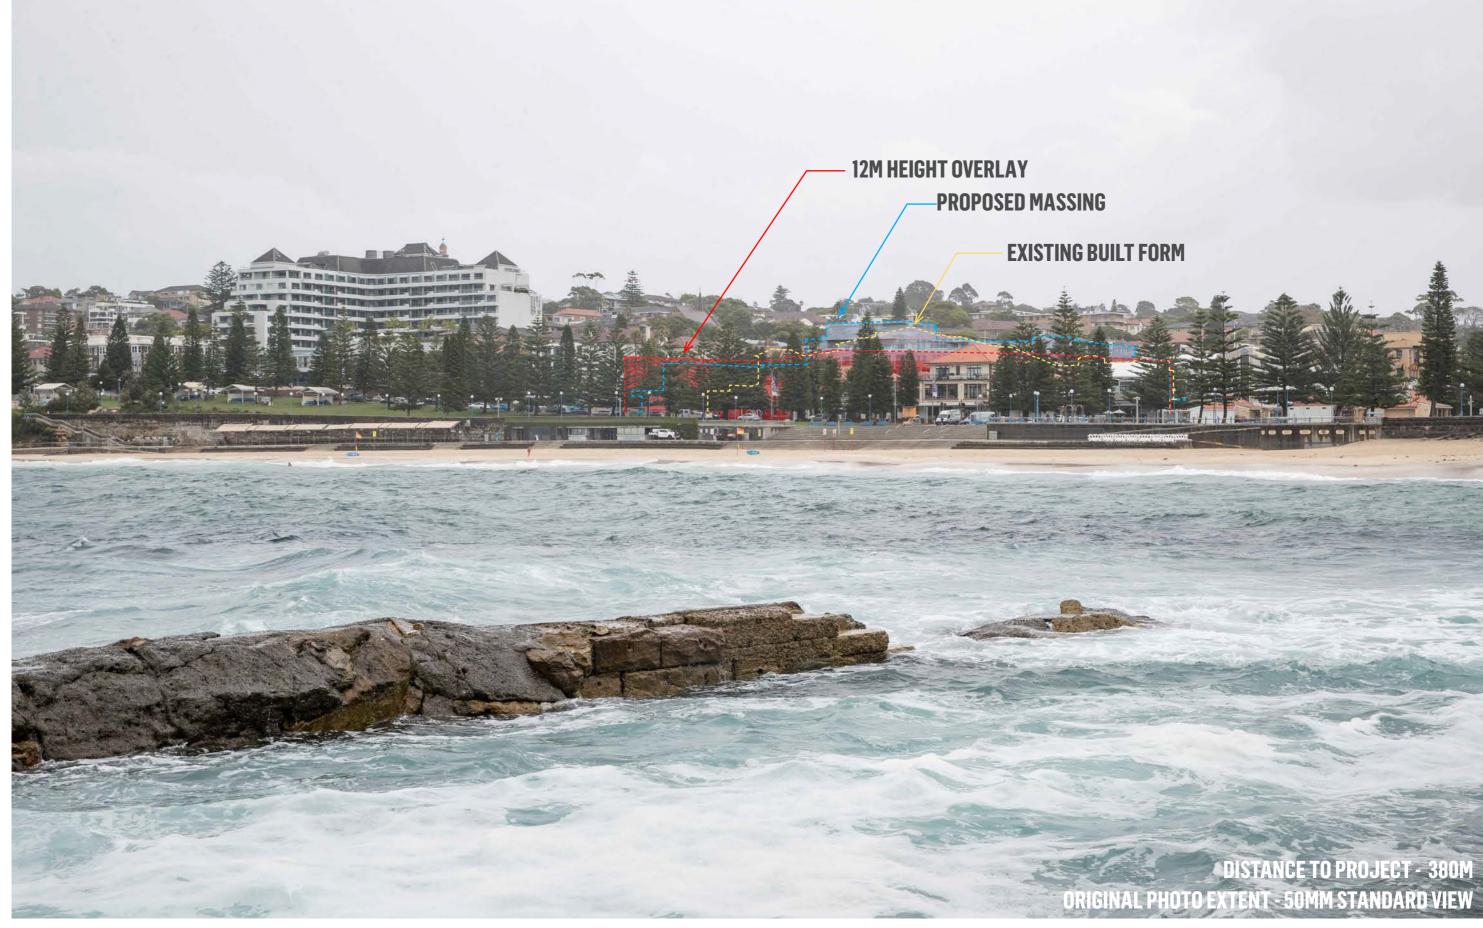

DATE: 2023-03-01 JOB NO: P0037817 DWG NO: VP_2C REV: -



COOGEE BAY HOTEL, COOGEE NSW - VIEW SHARING ASSESSMENT VP3 : (PHOTO 1115017) LOOKING WSW, GOLDSTEIN RESERVE | EXISTING PHOTO : 2022-01-19 9:59 AEDT

ORIGINAL PHOTO EXTENT - 35MM VIEW

DATE: 2023-03-01 JOB NO: P0037817 DWG NO: VP_3A REV: -





COOGEE BAY HOTEL, COOGEE NSW - VIEW SHARING ASSESSMENT VP3 : (PHOTO 1115017) LOOKING WSW, GOLDSTEIN RESERVE | CAMERA MATCH 3D MODEL TO PHOTO

DATE: 2023-03-01 JOB NO: P0037817 DWG NO: VP_3B REV: -



COOGEE BAY HOTEL, COOGEE NSW - VIEW SHARING ASSESSMENT VP3 : (PHOTO 1115017) LOOKING WSW, GOLDSTEIN RESERVE | PHOTO-SIMULATION

DISTANCE TO PROJECT - 380M ORIGINAL PHOTO EXTENT - 35MM VIEW

> DATE: 2023-03-01 JOB NO: P0037817 DWG NO: VP_3C REV: -





COOGEE BAY HOTEL, COOGEE NSW - VIEW SHARING ASSESSMENT VP4 : (PHOTO 1115029) LOOKING WSW, COOGEE BEACH | EXISTING PHOTO : 2022-01-19 10:26 AEDT

DATE: 2023-03-01 JOB NO: P0037817 DWG NO: VP_4A REV: -



COOGEE BAY HOTEL, COOGEE NSW - VIEW SHARING ASSESSMENT VP4 : (PHOTO 1115029) LOOKING WSW, COOGEE BEACH | CAMERA MATCH 3D MODEL TO PHOTO


DATE: 2023-03-01 JOB NO: P0037817 DWG NO: VP_4B REV: -





COOGEE BAY HOTEL, COOGEE NSW - VIEW SHARING ASSESSMENT VP4 : (PHOTO 1115029) LOOKING WSW, COOGEE BEACH | PHOTO-SIMULATION



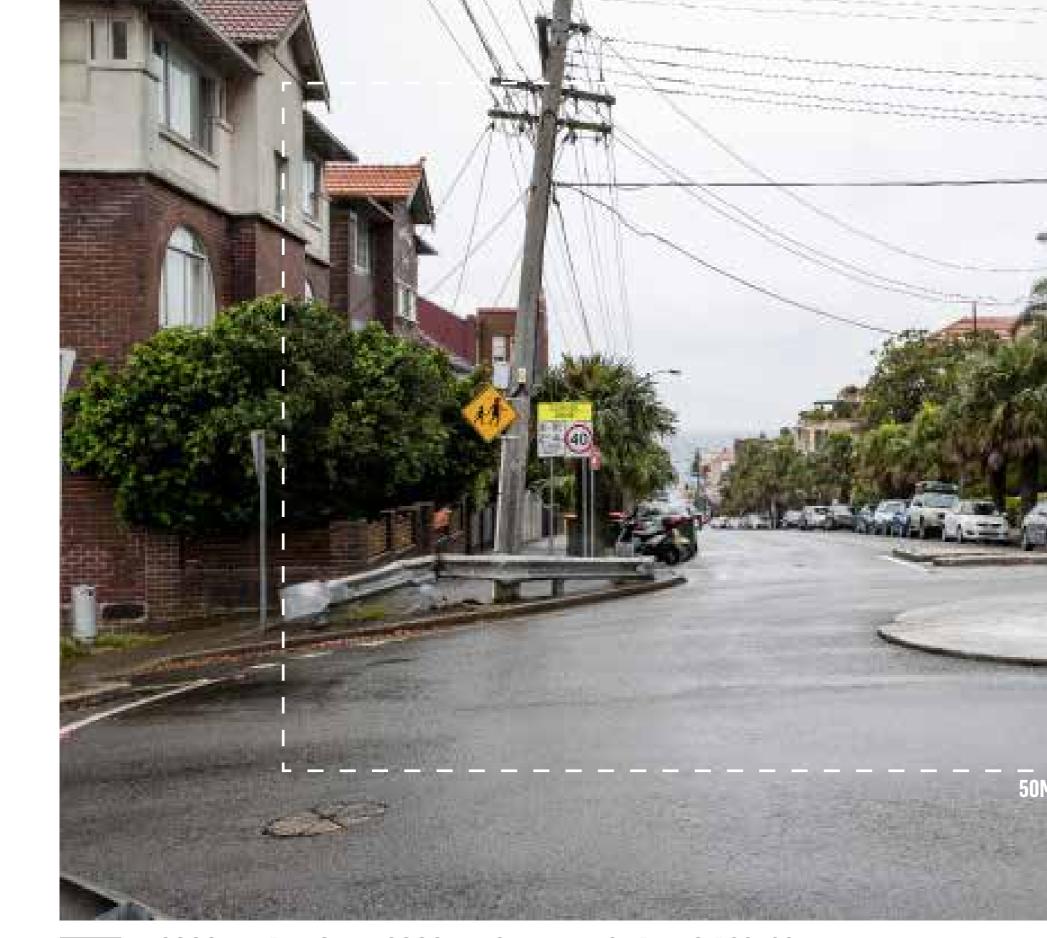

COOGEE BAY HOTEL, COOGEE NSW - VIEW SHARING ASSESSMENT VP5 : (PHOTO 11I5037) LOOKING ESE, MOUNT ST / COOGEE BAY RD INTERSECTION | EXISTING PHOTO : 2022-01-19 10:40 AEDT

50MM STANDARD VIEW - REFERENCE

ORIGINAL PHOTO EXTENT - 35MM VIEW



DATE: 2023-03-01 JOB NO: P0037817 DWG NO: VP_5A REV: -





COOGEE BAY HOTEL, COOGEE NSW - VIEW SHARING ASSESSMENT VP5 : (PHOTO 11I5037) LOOKING ESE, MOUNT ST / COOGEE BAY RD INTERSECTION | CAMERA MATCH 3D MODEL TO PHOTO

ORIGINAL PHOTO EXTENT - 35MM VIEW

DATE: 2023-03-01 JOB NO: P0037817 DWG NO: VP_5B REV: -



COOGEE BAY HOTEL, COOGEE NSW - VIEW SHARING ASSESSMENT VP5 : (PHOTO 11I5037) LOOKING ESE, MOUNT ST / COOGEE BAY RD INTERSECTION | PHOTO-SIMULATION

DISTANCE TO PROJECT - 345M ORIGINAL PHOTO EXTENT - 35MM VIEW

DATE: 2023-03-01 JOB NO: P0037817 DWG NO: VP_5C REV: -



COOGEE BAY HOTEL, COOGEE NSW - VIEW SHARING ASSESSMENT VP7 : (PHOTO 1115046) LOOKING ESE, 79/57-63 ST PAULS ST | EXISTING PHOTO : 2022-01-19 13:21 AEDT



ORIGINAL PHOTO EXTENT - 50MM STANDARD VIEW

DATE: 2023-03-01 JOB NO: P0037817 DWG NO: VP_7A REV: -





COOGEE BAY HOTEL, COOGEE NSW - VIEW SHARING ASSESSMENT VP7 : (PHOTO 1115046) LOOKING ESE, 79/57-63 ST PAULS ST | CAMERA MATCH 3D MODEL TO PHOTO

DATE: 2023-03-01 JOB NO: P0037817 DWG NO: VP_7B REV: -





COOGEE BAY HOTEL, COOGEE NSW - VIEW SHARING ASSESSMENT VP7 : (PHOTO 1115046) LOOKING ESE, 79/57-63 ST PAULS ST | PHOTO-SIMULATION

DATE: 2023-03-01 JOB NO: P0037817 DWG NO: VP_7C REV: -



COOGEE BAY HOTEL, COOGEE NSW - VIEW SHARING ASSESSMENT VP8 : (PHOTO 1115060) LOOKING EAST, 1/113 BROOK ST | EXISTING PHOTO : 2022-01-19 14:35 AEDT ORIGINAL PHOTO EXTENT - 50MM STANDARD VIEW

DATE: 2023-03-01 JOB NO: P0037817 DWG NO: VP_8A REV: -





COOGEE BAY HOTEL, COOGEE NSW - VIEW SHARING ASSESSMENT VP8 : (PHOTO 1115060) LOOKING EAST, 1/113 BROOK ST | CAMERA MATCH 3D MODEL TO PHOTO

DATE: 2023-03-01 JOB NO: P0037817 DWG NO: VP_8B REV: -





COOGEE BAY HOTEL, COOGEE NSW - VIEW SHARING ASSESSMENT VP8 : (PHOTO 1115060) LOOKING EAST, 1/113 BROOK ST | PHOTO-SIMULATION DISTANCE TO PROJECT - 70M ORIGINAL PHOTO EXTENT - 50MM STANDARD VIEW

> DATE: 2023-03-01 JOB NO: P0037817 DWG NO: VP_8C REV: -



COOGEE BAY HOTEL, COOGEE NSW - VIEW SHARING ASSESSMENT VP9A : (PHOTO 1115075) LOOKING ESE, 21/183 COOGEE BAY RD - LVL 6 | EXISTING PHOTO : 2022-01-20 8:40 AEDT



DATE: 2023-03-01 JOB NO: P0037817 DWG NO: VP_9A_A REV: -



COOGEE BAY HOTEL, COOGEE NSW - VIEW SHARING ASSESSMENT VP9A : (PHOTO 1115075) LOOKING ESE, 21/183 COOGEE BAY RD - LVL 6 | CAMERA MATCH 3D MODEL TO PHOTO




ORIGINAL PHOTO EXTENT - 50MM STANDARD VIEW

DATE: 2023-03-01 JOB NO: P0037817 DWG NO: VP_9A_B REV: -



COOGEE BAY HOTEL, COOGEE NSW - VIEW SHARING ASSESSMENT VP9A : (PHOTO 1115075) LOOKING ESE, 21/183 COOGEE BAY RD - LVL 6 | PHOTO-SIMULATION

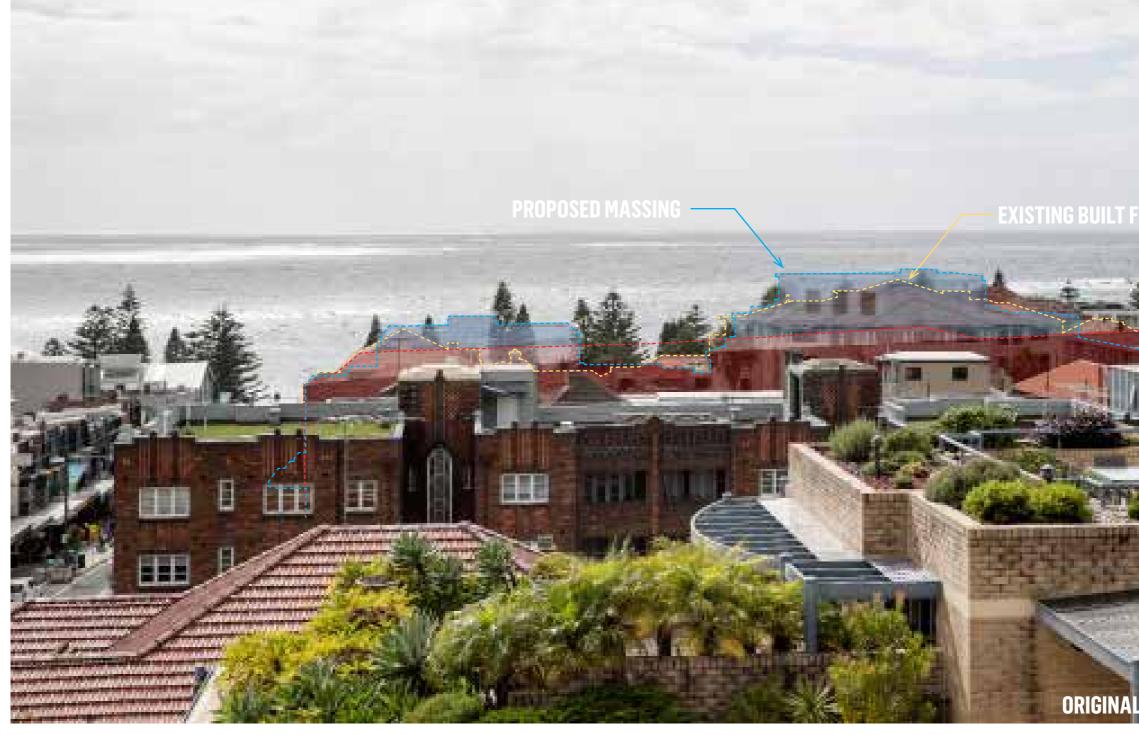

WEDDING CAKE - Island

12M HEIGHT OVERLAY

DISTANCE TO PROJECT - 170M ORIGINAL PHOTO EXTENT - 50MM STANDARD VIEW

> DATE: 2023-03-01 JOB NO: P0037817 DWG NO: VP_9A_C REV: -



COOGEE BAY HOTEL, COOGEE NSW - VIEW SHARING ASSESSMENT VP9B : (PHOTO 1115080) LOOKING ESE, 19/183 COOGEE BAY RD - LVL 5 | EXISTING PHOTO : 2022-01-20 8:52 AEDT



DATE: 2023-03-01 JOB NO: P0037817 DWG NO: VP_9B_A REV: -



COOGEE BAY HOTEL, COOGEE NSW - VIEW SHARING ASSESSMENT VP9B : (PHOTO 11I5080) LOOKING ESE, 19/183 COOGEE BAY RD - LVL 5 | CAMERA MATCH 3D MODEL TO PHOTO



DATE: 2023-03-01 JOB NO: P0037817 DWG NO: VP_9B_B REV: -



COOGEE BAY HOTEL, COOGEE NSW - VIEW SHARING ASSESSMENT VP9B : (PHOTO 1115080) LOOKING ESE, 19/183 COOGEE BAY RD - LVL 5 | PHOTO-SIMULATION



WEDDING CAKE ISLAND

12M HEIGHT OVERLAY

DISTANCE TO PROJECT - 160M ORIGINAL PHOTO EXTENT - 50MM STANDARD VIEW

> DATE: 2023-03-01 JOB NO: P0037817 DWG NO: VP_9B_C REV: -



COOGEE BAY HOTEL, COOGEE NSW - VIEW SHARING ASSESSMENT VP14A : (PHOTO 11I5140) LOOKING ESE, 1/180-196 COOGEE BAY RD - LVL 2 | EXISTING PHOTO : 2022-02-20 11:22 AEDT



DATE: 2023-03-01 JOB NO: P0037817 DWG NO: VP_14A_A REV: -



COOGEE BAY HOTEL, COOGEE NSW - VIEW SHARING ASSESSMENT VP14A : (PHOTO 1115140) LOOKING ESE, 1/180-196 COOGEE BAY RD - LVL 2 | CAMERA MATCH 3D MODEL TO PHOTO

DATE: 2023-03-01 JOB NO: P0037817 DWG NO: VP_14A_B REV: -



COOGEE BAY HOTEL, COOGEE NSW - VIEW SHARING ASSESSMENT VP14A : (PHOTO 1115140) LOOKING ESE, 1/180-196 COOGEE BAY RD - LVL 2 | PHOTO-SIMULATION



DATE: 2023-03-01 JOB NO: P0037817 DWG NO: VP_14A_C REV: -



COOGEE BAY HOTEL, COOGEE NSW - VIEW SHARING ASSESSMENT VP14B : (PHOTO 1115132) LOOKING SSE, 5/180-196 COOGEE BAY RD - LVL 3 | EXISTING PHOTO : 2022-01-20 11:18 AEDT



DATE: 2023-03-01 JOB NO: P0037817 DWG NO: VP_14B_A REV: -






COOGEE BAY HOTEL, COOGEE NSW - VIEW SHARING ASSESSMENT VP14B : (PHOTO 11I5132) LOOKING SSE, 5/180-196 COOGEE BAY RD - LVL 3 | CAMERA MATCH 3D MODEL TO PHOTO

DATE: 2023-03-01 JOB NO: P0037817 DWG NO: VP_14B_B REV: -



COOGEE BAY HOTEL, COOGEE NSW - VIEW SHARING ASSESSMENT VP14B : (PHOTO 1115132) LOOKING SSE, 5/180-196 COOGEE BAY RD - LVL 3 | PHOTO-SIMULATION

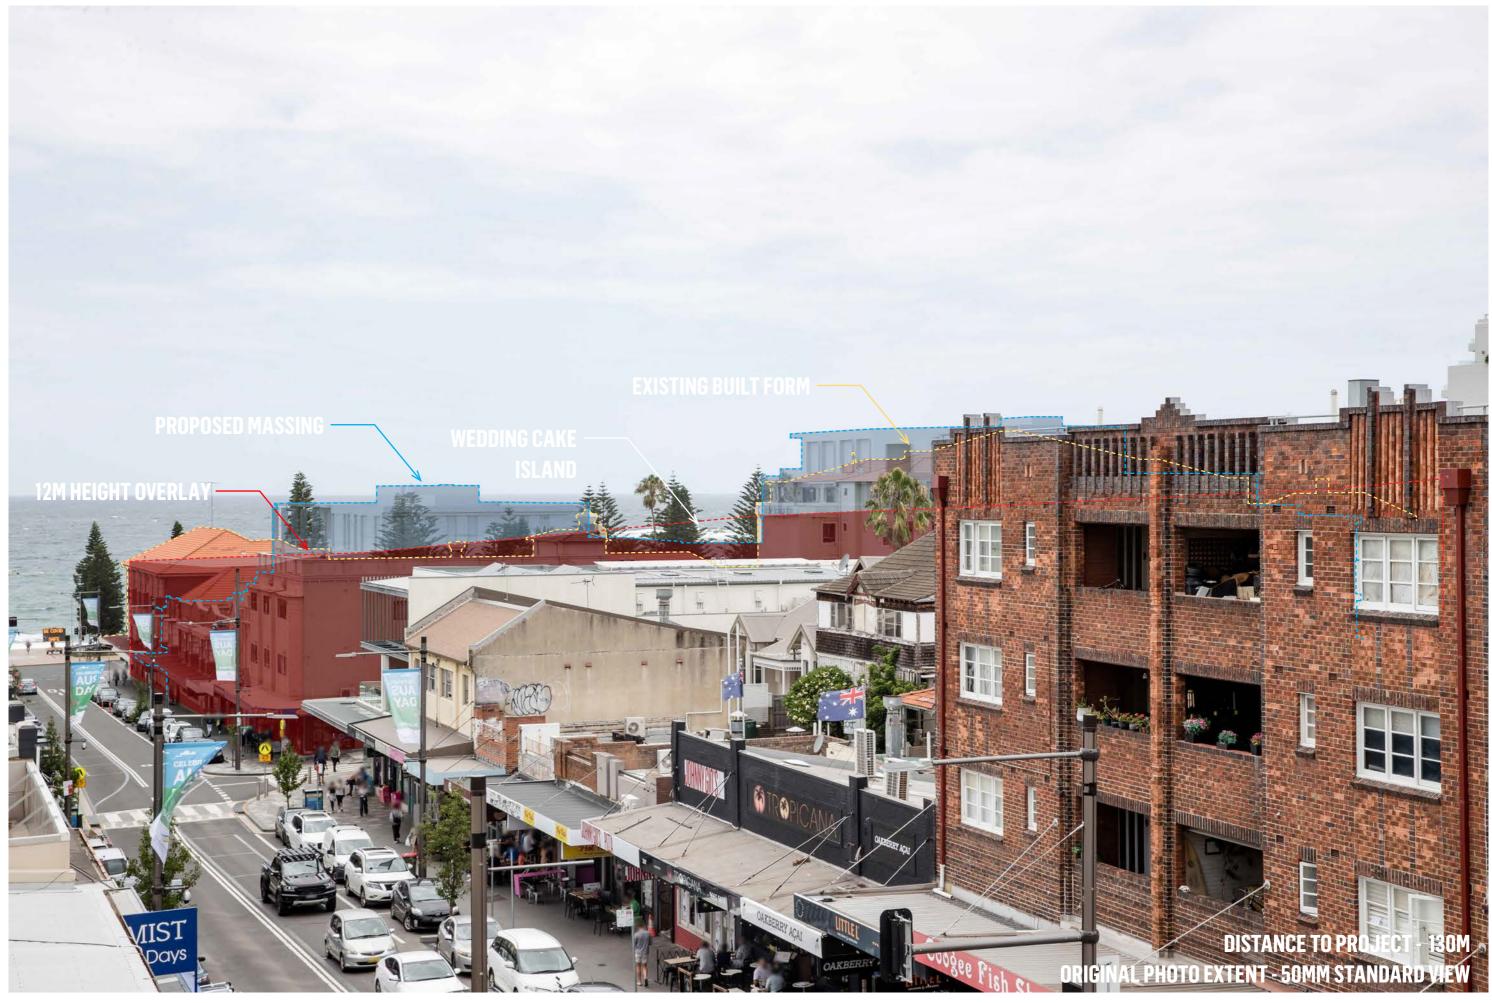

DATE: 2023-03-01 JOB NO: P0037817 DWG NO: VP_14B_C REV: -



COOGEE BAY HOTEL, COOGEE NSW - VIEW SHARING ASSESSMENT VP15 : (PHOTO 1115181) LOOKING ENE, 9/41-43 CARR ST - LVL 3 | EXISTING PHOTO : 2022-01-20 13:33 AEDT

DATE: 2023-03-01 JOB NO: P0037817 DWG NO: VP_15A REV: -





COOGEE BAY HOTEL, COOGEE NSW - VIEW SHARING ASSESSMENT VP15 : (PHOTO 1115181) LOOKING ENE, 9/41-43 CARR ST - LVL 3 | CAMERA MATCH 3D MODEL TO PHOTO

DATE: 2023-03-01 JOB NO: P0037817 DWG NO: VP_15B REV: -



URBIS COOGEE BAY HOTEL, COOGEE NSW - VIEW SHARING ASSESSMENT VP15 : (PHOTO 1115181) LOOKING ENE, 9/41-43 CARR ST - LVL 3 | PHOTO-SIMULATION

DATE: 2023-03-01 JOB NO: P0037817 DWG NO: VP_15C REV: -



COOGEE BAY HOTEL, COOGEE NSW - VIEW SHARING ASSESSMENT VP16 : (PHOTO 1115174) LOOKING EAST, 17 VICAR ST | EXISTING PHOTO : 2022-01-20 12:56 AEDT



ORIGINAL PHOTO EXTENT - 50MM STANDARD VIEW

DATE: 2023-03-01 JOB NO: P0037817 DWG NO: VP_16A REV: -



COOGEE BAY HOTEL, COOGEE NSW - VIEW SHARING ASSESSMENT VP16 : (PHOTO 1115174) LOOKING EAST, 17 VICAR ST | CAMERA MATCH 3D MODEL TO PHOTO

JOB NO: P0037817 DWG NO: VP_16B REV: -





COOGEE BAY HOTEL, COOGEE NSW - VIEW SHARING ASSESSMENT VP16 : (PHOTO 1115174) LOOKING EAST, 17 VICAR ST | PHOTO-SIMULATION

DATE: 2023-03-01 JOB NO: P0037817 DWG NO: VP_16C REV: -




COOGEE BAY HOTEL, COOGEE NSW - VIEW SHARING ASSESSMENT VP17A : (PHOTO 11I5200) LOOKING EAST, 5/14-24 KIDMAN ST | EXISTING PHOTO : 2022-01-20 14:21 AEDT



DATE: 2023-03-01 JOB NO: P0037817 DWG NO: VP_17A_A REV: -



COOGEE BAY HOTEL, COOGEE NSW - VIEW SHARING ASSESSMENT VP17A : (PHOTO 11I5200) LOOKING EAST, 5/14-24 KIDMAN ST | CAMERA MATCH 3D MODEL TO PHOTO

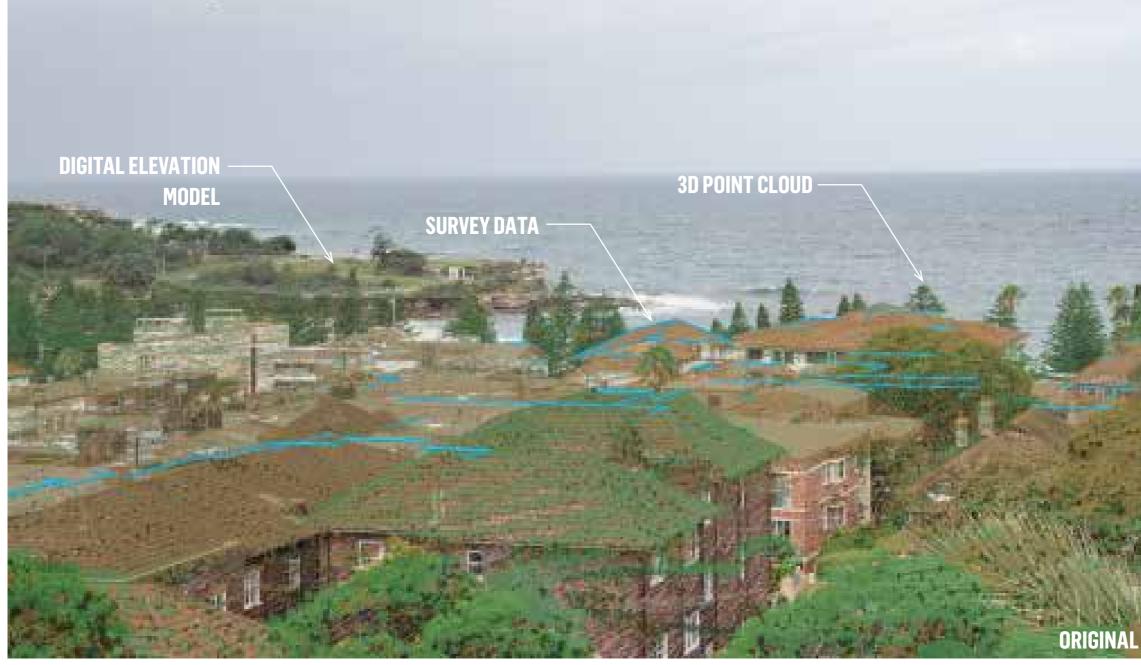

ORIGINAL PHOTO EXTENT - 50MM STANDARD VIEW

DATE: 2023-03-01 JOB NO: P0037817 DWG NO: VP_17A_B REV: -





COOGEE BAY HOTEL, COOGEE NSW - VIEW SHARING ASSESSMENT VP17A : (PHOTO 11I5200) LOOKING EAST, 5/14-24 KIDMAN ST | PHOTO-SIMULATION

DATE: 2023-03-01 JOB NO: P0037817 DWG NO: VP_17A_C REV: -



COOGEE BAY HOTEL, COOGEE NSW - VIEW SHARING ASSESSMENT VP17B : (PHOTO 11I5207) LOOKING EAST, 3/14-24 KIDMAN ST | EXISTING PHOTO : 2022-01-20 14:30 AEDT



DATE: 2023-03-01 JOB NO: P0037817 DWG NO: VP_17B_A REV: -



COOGEE BAY HOTEL, COOGEE NSW - VIEW SHARING ASSESSMENT VP17B : (PHOTO 11I5207) LOOKING EAST, 3/14-24 KIDMAN ST | CAMERA MATCH 3D MODEL TO PHOTO



DATE: 2023-03-01 JOB NO: P0037817 DWG NO: VP_17B_B REV: -





COOGEE BAY HOTEL, COOGEE NSW - VIEW SHARING ASSESSMENT VP17B : (PHOTO 11I5207) LOOKING EAST, 3/14-24 KIDMAN ST | PHOTO-SIMULATION

DATE: 2023-03-01 JOB NO: P0037817 DWG NO: VP_17B_C REV: -



COOGEE BAY HOTEL, COOGEE NSW - VIEW SHARING ASSESSMENT VP18 : (PHOTO 1115188) LOOKING ENE, 5/119 BROOK ST | EXISTING PHOTO : 2022-01-20 13:56 AEDT



ORIGINAL PHOTO EXTENT - 50MM STANDARD VIEW

DATE: 2023-03-01 JOB NO: P0037817 DWG NO: VP_18A REV: -



URBIS

COOGEE BAY HOTEL, COOGEE NSW - VIEW SHARING ASSESSMENT VP18 : (PHOTO 11I5188) LOOKING ENE, 5/119 BROOK ST | CAMERA MATCH 3D MODEL TO PHOTO

ORIGINAL PHOTO EXTENT - 50MM STANDARD VIEW

DATE: 2023-03-01 JOB NO: P0037817 DWG NO: VP_18B REV: -



URBIS

COOGEE BAY HOTEL, COOGEE NSW - VIEW SHARING ASSESSMENT VP18 : (PHOTO 1115188) LOOKING ENE, 5/119 BROOK ST | PHOTO-SIMULATION

DATE: 2023-03-01 JOB NO: P0037817 DWG NO: VP_18C REV: -

APPENDIX 2 AE DESIGN PHOTOMONTAGES

15 September 2022

Jane Maze-Riley Urbis Level 8 Angel Place, 123 Pitt Street Sydney NSW 2000

Dear Jane,

SIMMATTOWN & CHEUNG PROPERTIES v RANDWICK CITY COUNCIL - PHOTOMONTAGES **Coogee Bay Hotel**

This letter has been prepared to accompany the Photomontages dated 14 September 2022 prepared by ae design partnership to assist with the NSW Land and Environment Court Proceedings 2021/00322119. I confirm that photomontages have been produced in accordance with the NSW Land and Environment Court Photomontage Policy.

Photographs were provided by Urbis and were taken from a height of 1.55m above ground at each vantage point with a Canon EOS 1D X Mark - 20 Megapixel digital SLR camera (Full-frame sensor) and lens model Canon EF 24-70mm f/2.8L II USM at 24mm, 35mm and 50mm focal lengths.

The data sources used to assist in preparing the photomontages and alignment of the wireframes are:

Data Object	Source
Contours and cadastre	NSW Government Spatial Services
3D aerial	Nearmap
Site survey	Client
Camera location survey	Urbis
12m height blanket 3D model	Fender Katsalidis
Proposed 3D model	Fender Katsalidis

Virtual cameras for each vantage point were created to prepare the photomontages based on the associated camera survey location coordinates and photo focal length in Rhino 7. From these virtual cameras, rendered views have been generated and photomontage into the existing photos using photoshop.

Should you have any further queries regarding the above matter, please contact me on 0419 245 956 or via email on rohan@aedesignstudio.com.au.

Sincerely, ae design partnership pty ltd

Rohan Dickson Director

Coogee Bay Hotel

Additional Views Requested By Council







LEGEND

Existing Building Wireframes

Proposed Building Wireframes

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FOCAL LENGTH: 35mm





WITHOUT PREJUDICE



Unit 5, 201 Coogee Bay Road







COOGEE BAY HOTEL



LEGEND

Existing Building Wireframes

Proposed Building Wireframes

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FOCAL LENGTH: 55mm

WITHOUT PREJUDICE



Unit 3, 130 Brook Street





WITHOUT PREJUDICE

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LOCATION:

FOCAL LENGTH: 35mm





DATE		
15/09/2022		
SSUE	SHEET	
A	03	







COOGEE BAY HOTEL

WITHOUT PREJUDICE



PHOTO LOCATION



LEGEND

Existing Building Wireframes

Proposed Building Wireframes

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LOCATION:

FOCAL LENGTH: 35mm



Unit 5, 134 Brook Street



Existing Building Wireframes

Proposed Building Wireframes

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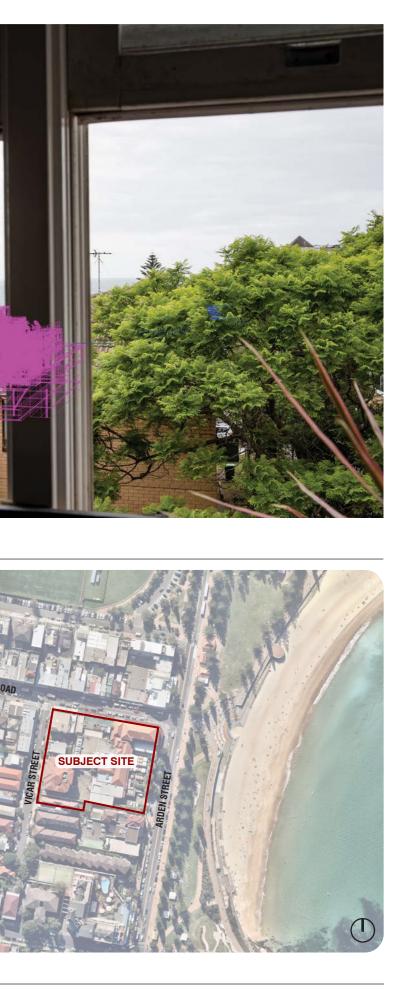


FOCAL LENGTH: 35mm

WITHOUT PREJUDICE

PROPOSED MODEL

COOGEE BAY HOTEL













COOGEE BAY HOTEL

WITHOUT PREJUDICE



PHOTO LOCATION



LEGEND

Existing Building Wireframes

Proposed Building Wireframes

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LOCATION:

FOCAL LENGTH: 24mm



Unit 15, 28 Kidman Street







COOGEE BAY HOTEL

WITHOUT PREJUDICE



PHOTO LOCATION



LEGEND

- Existing Building Wireframes
- Proposed Building Wireframes

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LOCATION:

FOCAL LENGTH: 35mm



SHEET 07

Unit 22, 183 Coogee Bay Road

APPENDIX 3 NEIGHBOURING DWELLINGS



Photo 7. Side setback between 1 and 7 Vicar Street, where spatial separation allows views of sky access to the east from parts of Vicar



Photo 5. Surrounding residential development, detail of 2 Vicar Street. This dwelling was inspected and views recorded confirm that there is no access to scenic or highly valued views from ground or first floor rooms due to the height and form of intervening development



Photo 6. Detail of 8-10 Vicar Street



Photo 8. Detail of 12-14 and 18-20 Vicar Street



Photo 9. Detail of 23-25 Vicar Street, south of the site



Photo 10. Detail of 130-132 Brook Street



Photo 11. Detail of 128 Brook Street on the corner of Brook and Kidman Streets



Photo 12. Detail of 122 and 124 Brook Street



Photo 13. Detail of 120 Brook Street



Photo 14. Detail of 117 and 119 Brook Street



Photo 15. View east to 109-111 Brook Street from Kidman Street



Photo 16. Detail of 109-111 Brook Street. We note the presence of evergreen, tree canopies to the east of this development which is likely to limit views access to the east



Photo 17. Side setback between 197 Coogee Bay Road and Adina Apartments at 183 Coogee Bay Road



Photo 18. View south-west from south-eastern corner of subject site



Photo 19. Arden Street streetscape including 230 Arden Street and other 3 and 4 storey and taller hotel development is present



Photo 20. Detail view of 11 Kidman Street



Photo 21. Detail view of 28 Kidman Street



Photo 22. 118 Brook Street and the east elevation of residential flat building at 197 CBH behind.



Photo 23.Detail view of residential flat building at 186 Coogee Bay
RoadRoadfrom roof top at 201 Coogee Bay Road-



Photo 24. Detail view of 201 Coogee Bay Road



Photo 25. Detail view of 130-132 Brook Street



Photo 26. Detail view of 56 Carr Street



Photo 27. Detail view of 41-43 Carr Street



Photo 28. Detail view of Adina residential apartments



Photo 29. East block of 14 Kidman Street. Views were inspected from the upper left hand units with easterly view to Coogee Bay



Photo 30. Streetscape view from the corner of Kidman and Brook Streets

EASTERLY VIEWS FROM TRAFFICABLE ROOFTOP 201 COOGEE BAY ROAD



Photo 31. View south-east to Wedding Cake Island from north-west corner of roof deck at 201 Coogee Bay Road

This is a view from the trafficable common area roof top across the site to Parts of Coogee Bay and Wedding Cake Island. This view was not selected for modelling given that is not a private or public domain location, and views from here are unlikely to be sustained for long periods of time. Views from other parts of the roof to the east and north-east are unaffected by the proposed development. Views from further south as shown in photos 31 and 31 do not include parts of Wedding Cake Island. This view has been modelled by Fender Katsalidis (refer to Photo 82).



Photo 32. View east from centre of roof deck at 201 Coogee Bay Road

Photo 33. View east from south end of the roof deck at 201 Coogee Bay Road





APPENDIX B

DRAWINGS SK125.1-SK125.3



(NOT TO BE UPLOADED TO PLANNING PORTAL) NOTE: *MINOR CHANGES TO FORM AND CONFIGURATION MAY BE REQUIRED WHEN DRAW

**MINOR CHARVES TO FORM AND CONTRECTOR STATES CONSENT **THE DESIGN IS NOT IN A FORM SUITABLE FOR USE IN CONNECTION WITH BUILDING WORK Bildows FRBUCTOD- Biblicode 1919 Cooper Bay Hosting MODELSD [7F-04.688 MIDEL191917 CBH General PROPOSED GFA AT EXISTING HOTEL


NOT TO SCALE

DATE 27/02/2023

PROPOSED GFA ABOVE 12M HEIGHT PLANE GENERALLY IN THELOCATION OF EXISTING BOUTIQUE HOTEL

LEVELS IMPACTED : - LEVEL 03 | 695m² - LEVEL 04 | 875m² - LEVEL 05 | 301m²

TOTAL AREA ABOVE 12m HEIGHT PLANE 1871m²

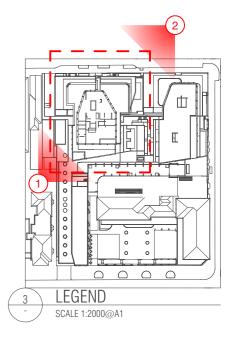



/ING NUMBER

SK125.1





NOT TO SCALE


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date 27/02/2023




LEVELS IMPACTED : - LEVEL 03 | 556m² - LEVEL 04 | 557m²

TOTAL AREA ABOVE 12m HEIGHT PLANE 1113m²



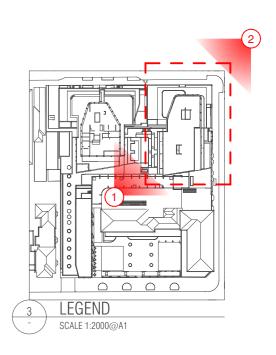



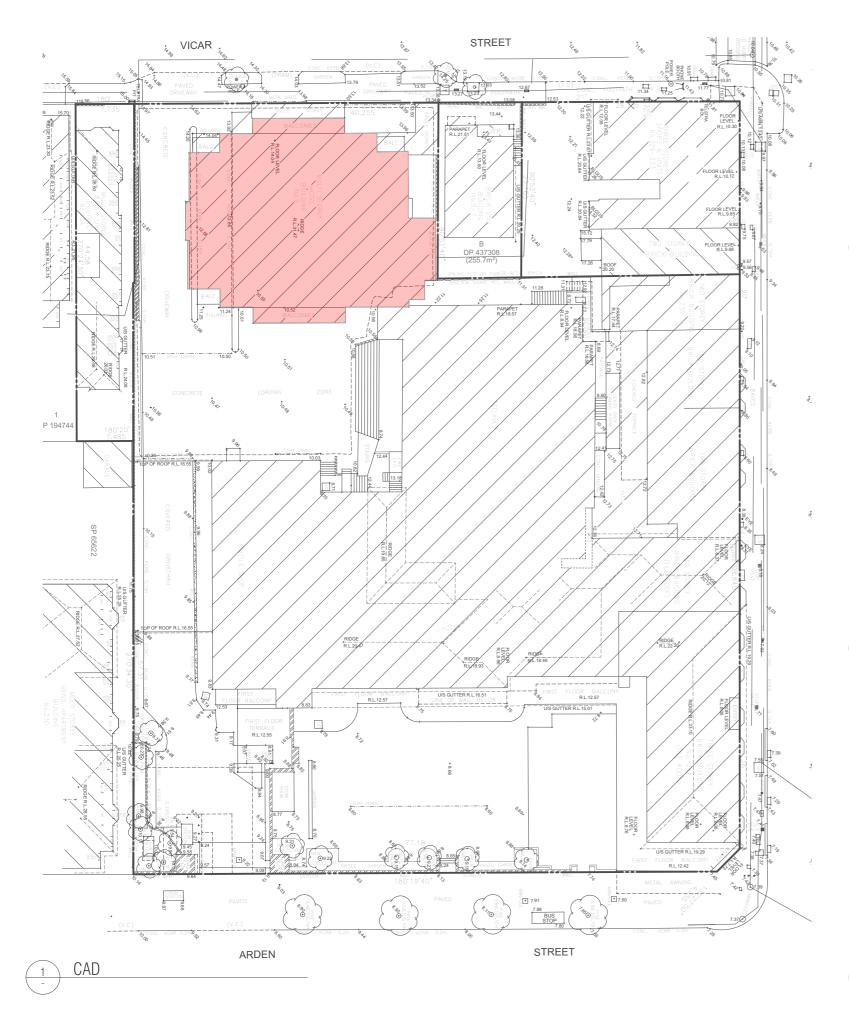


Coogee Bay Hotel & Surrounding Buildings

GFA Area Schedule

9 Vicar Street	m²
Basement Lobby	26
Ground Floor Lobby	162
First Floor	574
Second Floor	616
Third Floor	616
Fourth Floor	570

210618 GFA CALCULATIONS 2

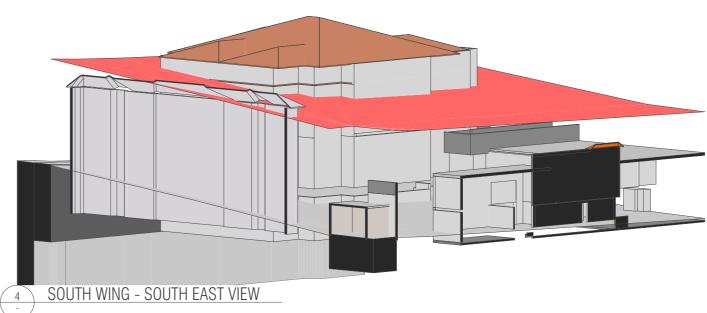



SOUTH WING - NORTH WEST VIEW 5

EXISTING GFA AT BOUTIQUE HOTEL

>

- ,2

EXISTING GFA ABOVE 12M HEIGHT PLANE BOUTIQUE HOTEL

- LEVELS IMPACTED : - LEVEL 03@50% - LEVEL 04

| 308m² | 570m²

TOTAL AREA ABOVE 12m HEIGHT PLANE 878m²





URBIS.COM.AU